MONTANA FISH, WILDLIFE, & PARKS MONTANA OUTDOORS OFFICE REMODEL

FWP Project #7199172

930 CUSTER AVENUE, HELENA, MT 59602



CWG Architecture

P.O. Box 1198 59624 650 Power Street Helena. Montana

Tel (406) 443-2340 Fax (406) 442-8565 cwg@cwg-architects.com

Architecture, Engineering & Design

MECHANICAL

MILLENIUM ENGINEERING, INC.
HELENA, MONTANA TEL 406-458-6599 FAX 406-458-6075

ELECTRICAL

F.S.

FTG.


FOOTING

AMES ENGINEERING LLC.
HELENA, MONTANA TEL 406-458-0494 FAX 406-458-0494



1. THIS IS A TYPE V-B, NON-SPRINKLED BUILDING. SEE SHEET A1.1 FOR CODE REVIEW. 2. DO NOT SCALE DRAWINGS. CONTRACTOR SHALL VERIFY ALL DIMENSIONS SIZES, QUANTITIES, & LOCATION BEFORE BEGINNING WORK 3. VERIFY LOCATION OF EXISTING UTILITIES PRIOR TO CONSTRUCTION. ANY UTILITIES LOCATED ARE SHOWN APPROXIMATE AND SHOULD NOT BE USED TO DETERMINE THEIR LOCATION ON THE GROUND, AND DOES NOT RELIEVE ANY PERSON OR COMPANY OF THEIR RESPONSIBILITY TO CONTACT ALL UTILITY COMPANIES PRIOR TO ANY EXCAVATION BY CALLING UTILITIES UNDERGROUND LOCATION CENTER AT 1-800-424-5555. 4. THERE ARE NO KNOWN HAZARDOUS MATERIALS STORED ON THE PREMISES AS DEFINED BY 2012 IBC 5. PROJECT SHALL COMPLY WITH THE 2018 IBC, 2018 IMC, 2018 IECC, 2017 NEC, 2018 IFC, 2018 UPC 6. WALL AND CEILING MATERIALS SHALL NOT EXCEED THE FLAME SPREAD CLASSIFICATION IBC 803.13 7. ELECTRONIC DRAWING FILES ARE AVAILABLE FROM THE ARCHITECT, STRUCTURAL, MECHANICAL AND ELECTRICAL ENGINEERS AT \$100.00 PER DRAWING & \$25.00 FOR PDF. DRAWINGS WILL BE STRIPPED OF ALL DATA EXCEPT FOR BASIC PLAN OR SECTION INFORMATION. A WAIVER WILL NEED TO BE SIGNED AND RECEIVED PRIOR TO RELEASE OF DRAWING FILES. 8. IT IS ABSOLUTELY NECESSARY THAT ALL TRADES COORDINATE WITH EACH OTHER AND VERIFY THAT THERE ARE NO CONFLICTS IN LOCATIONS OF DUCTS, CONDUITS, SPRINKLER HEADS, DIFFUSERS, ELECTRICAL BOXES, EQUIPMENT AND OTHER ITEMS THROUGHOUT THIS PROJECT BEFORE FINAL PLACEMENT OF MATERIALS. 9. REFER TO STRUCTURAL DRAWING AND SPECIFICATIONS FOR SPECIAL INSPECTION INFORMATION.


SUBMITTAL DOCUMENTS FOR DEFERRED SUBMITTAL ITEMS SHALL BE SUBMITTED TO THE REGISTERED DESIGN PROFESSIONAL IN RESPONSIBLE CHARGE, WHO SHALL REVIEW THEM AND FORWARD THEM TO THE BUILDING OFFICIAL WITH A NOTATION INDICATING THAT THE DEFERRED SUBMITTAL DOCUMENTS HAVE BEEN REVIEWED AND THAT THEY HAVE BEEN FOUND TO BE IN GENERAL CONFORMATION WITH THE BUILDING DESIGN. THE DEFERRED SUBMITTAL ITEMS SHALL NOT BE INSTALLED UNTIL THEIR DESIGN AND SUBMITTAL DOCUMENTS HAVE BEEN APPROVED BY THE BUILDING OFFICIAL.

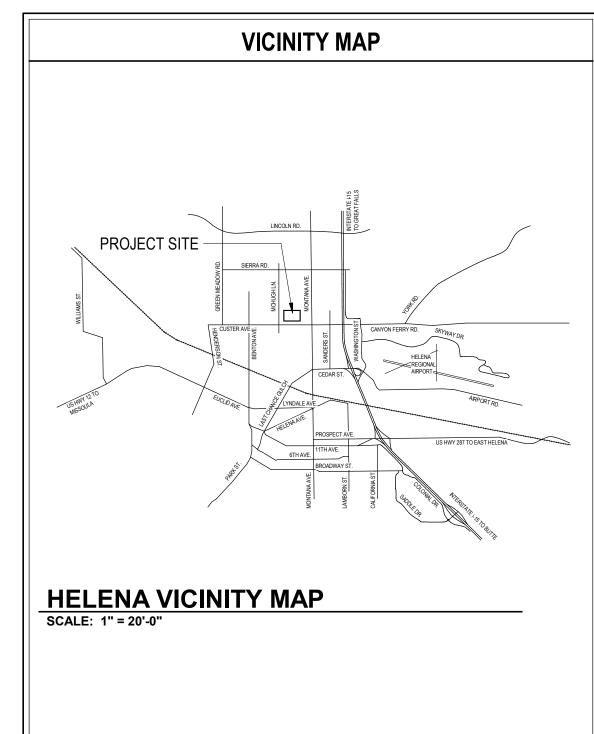




WOOD

WDW. WINDOW

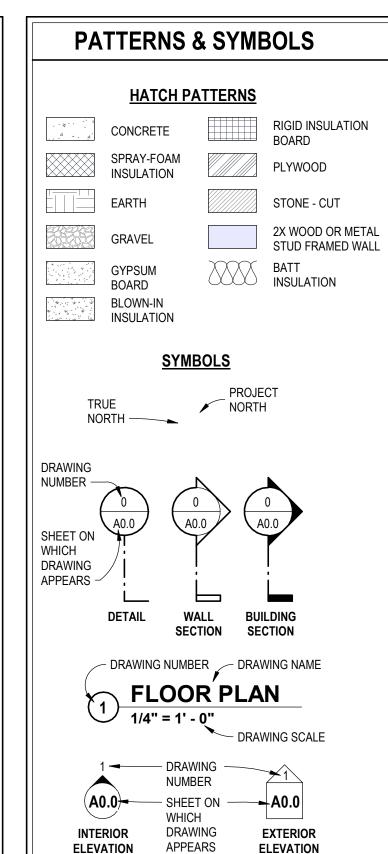



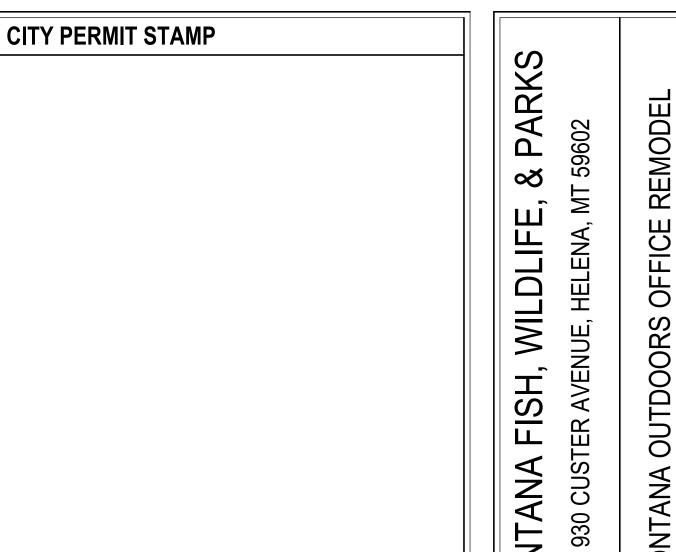


23-153-01

COVER SHEET

DATE 10.18.21

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LDLIFE, & PARKS ORS OFFICE REMC WILD OOR ELENA,

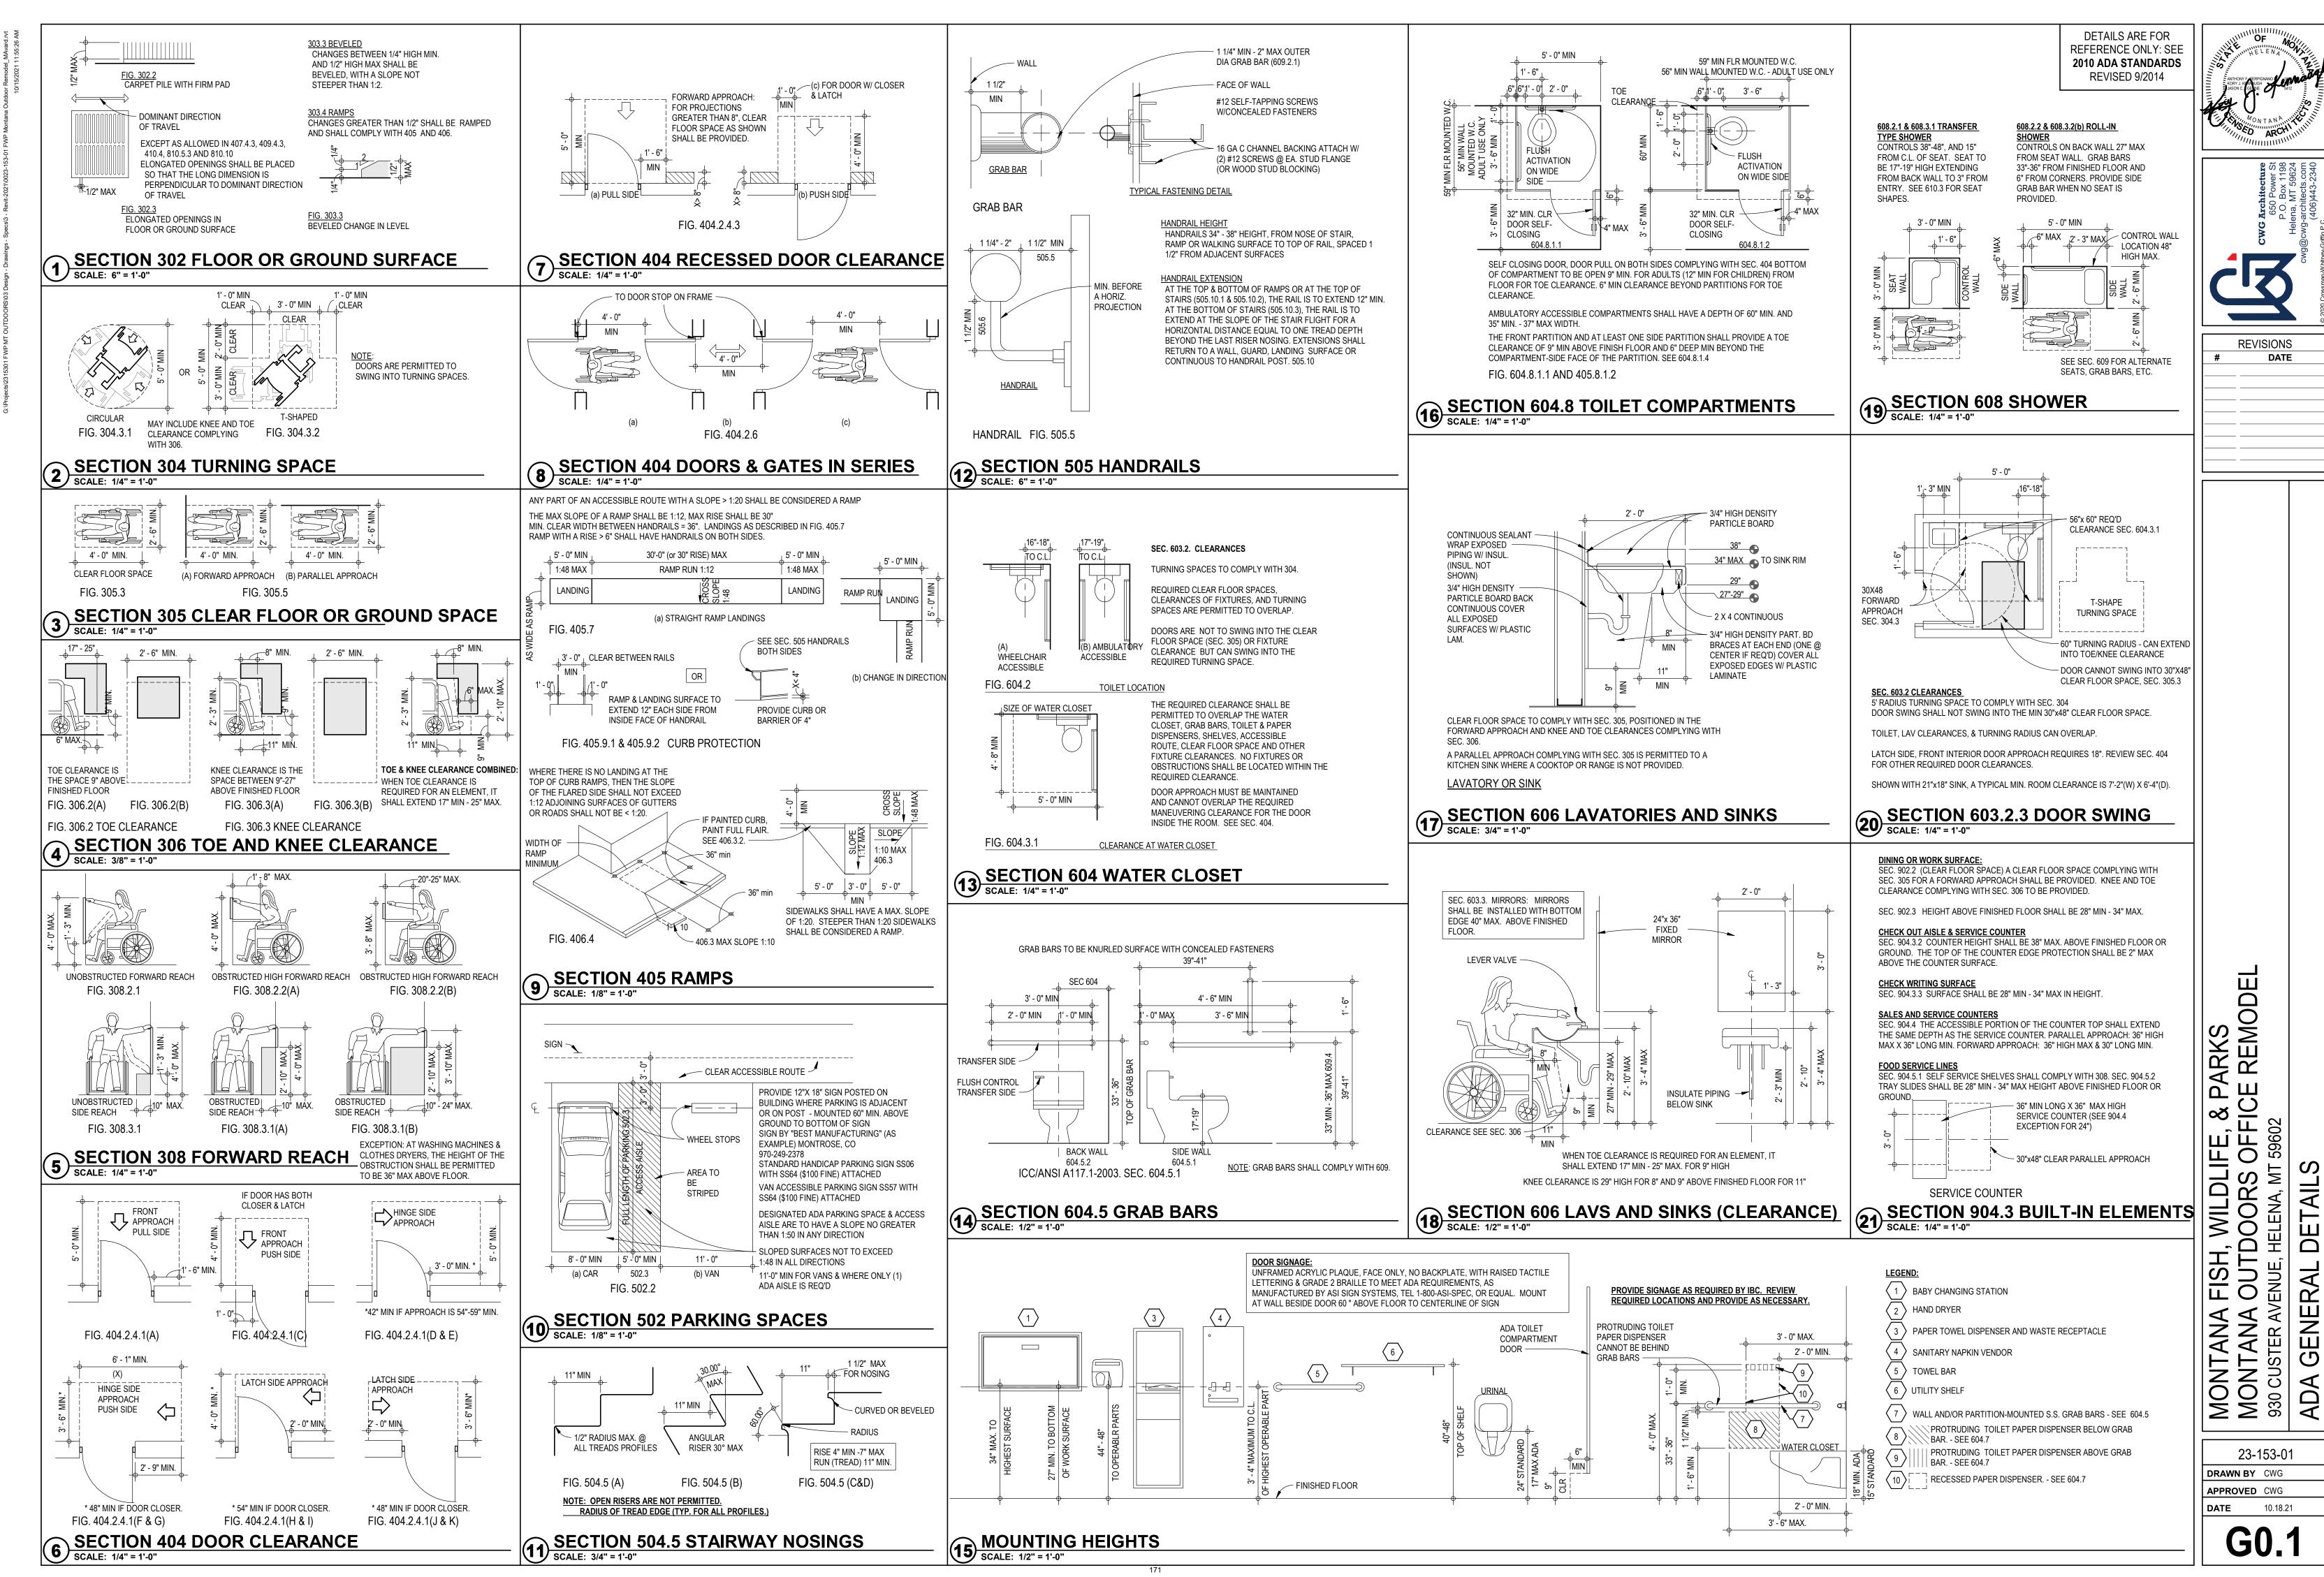23-153-01 **DRAWN BY** CWG APPROVED CWG

RAL

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DATE 10.18.21 G0.1

GENERAL DEMO PLAN NOTES

COORDINATE ALL WORK IN (E) BUILDING WITH OWNER, PORTIONS OF THE BUILDING WILL REMAIN OCCUPIED DURING CONSTRUCTION, CONTRACTOR TO COORDINATE W/ OWNER FOR SEQUENCING OF DEMOLITION TO

MINIMIZE IMPACT TO BUSINESS OPERATIONS.

. CONTRACTOR TO COORDINATE WITH OWNER BEFORE START OF DEMO FOR OWNER TO REMOVE FURNITURE, EQUIPMENT AND OWNER SALAVAGED ITEMS. SEE MECHANICAL, ELECTRICAL DRAWINGS FOR ADDITIONAL DEMO NOTES

PROTECT EXISTING CONSTRUCTION TO REMAIN, REPAIR ANY DAMAGE TO MATCH EXISTING ADJACENT CONSTRUCTION OR REPLACE ITEMS AS REQUIRED. CONTRACTOR TO FIELD VERIFY EXISTING CONDITIONS PRIOR TO BEGINNING DEMOLITION. NOTIFY ARCHITECT/OWNER OF ANY ITEMS THAT WOULD INTERFERE WITH PROCEEDING WITH DEMOLITION AS INDICATED OR DEVIATES FROM ASSUMED CONDITIONS.

CONTRACTOR TO COMPLY WITH ALL EPA, FEDERAL, STATE AND LOCAL REGULATIONS FOR DISPOSAL OF CONSTRUCTION MATERIALS. REMOVAL AND DISPOSAL OF ALL DEMOLISHED ITEMS WITHIN THE LIMIT OF WORK AREA UNLESS OTHERWISE NOTED. CONTRACTOR TO PROVIDE ALL TEMPORARY PARTITIONS AND OTHER SYSTEMS TO CONTROL THE SPREAD OF CONSTRUCTION DEBRIS & DUST. CONTRACTOR TO PROVIDE ALL TEMPORARY SHORING AND BRACING, SEE

8. PATCH AND REPAIR ANY FINISHES TO MATCH ADJACENT FINISHES.

DEMO KEY NOTES:

(D1) SAWCUT EXTERIOR/INTERIOR CMU BLOCK WALL FOR NEW OPENING, SEE WINDOW & DOOR LEGEND

D2 REMOVE EXISTING INTERIOR FRAMED WALL COMPLETELY

(D3) REMOVE EXISTING EXTERIOR/INTERIOR DOOR/ DOOR FRAME & DOOR HARDWARE COMPLETELY

⟨D4⟩ REMOVE EXISTING INTERIOR WINDOW COMPLETELY

 \langle D5 \rangle REMOVE EXISTING RUBBER BASE COMPLETELY, PREP WALL SURFACE FOR NEW RUBBER BASE REMOVE EXISTING BROADLOOM CARPET OR LVT FLOORING COMPLETELY, PREP FLOOR SURFACE

D6 FOR NEW FLOOR FINISHES REMOVE EXISTING WALL CASEWORK AND SELVING COMPLETELY, PATCH AND REPAIR WALL FOR NEW FINISHES

⟨D8⟩ REMOVE EXISTING CEILING TILES & GRID COMPLETELY

REMOVE EXISTING 12" X 12" FULLY ADHERED CEILING SYSTEM AND FRAMING SYSTEM COMPLETELY,

PREP FOR NEW LAY-IN CEILING SYSTEM D10 REMOVE EXISTING ELECTRICAL BREAKER PANEL. SEE ELEC.

211 REMOVE & RELOCATE EXISTING FIRE EXTINGUISHER 212 REMOVE & RELOCATE EXISTING BASE CABINETS W/ COUNTERTOPS

D13 REMOVE EXISTING BASE & UPPER CASEWORK AND/OR WALL SHELVING COMPLETELY.

(D14) REMOVE EXISTING GYP. BD. TO 5' - 0" A.F.F.

COGNIZANT NOTE: THE CONTRACTOR SHALL BE COGNIZANT THAT THIS IS A REMODEL PROJECT AND AS SUCH, CERTAIN ITEMS CANNOT BE FULLY ILLUSTRATED NOR EXPLAINED WITHOUT FIELD OBSERVATION. THEREFORE BEFORE SUBMITTING A PROPOSAL, THE CONTRACTOR SHALL VISIT AND EXAMINE THE PROJECT IN EVERY DETAIL AS PERTAINS TO THIS PROJECT AND MAKE ALLOWANCES IN THEIR PROPOSAL FOR ALL CONDITIONS THAT WILL AFFECT THE WORK INDICATED IN THE PROJECT MANUAL AND CONTRACT DOCUMENT

COORDINATION NOTE IT IS ABSOLUTELY NECESSARY THAT ALL TRADES COORDINATE WITH EACH OTHER AND VERIFY THAT THERE ARE NO CONFLICTS IN LOCATION OF DUCTS, CONDUITS, SPRINKLER HEADS, DIFFUSERS, ELECTRICAL BOXES, EQUIPMENT, AND OTHER ITEMS THROUGHOUT THIS PROJECT BEFORE FINAL PLACEMENT OF MATERIALS.

REVISIONS

DATE

23-153-01 DRAWN BY MMA APPROVED CWG **DATE** 10.18.21

MONTANA FISH, WILDLIFE, & PARKS
MONTANA OUTDOORS OFFICE REMOD
930 CUSTER AVENUE, HELENA, MT 59602

DEMO PLAN

SEALANT JOINT

STEEL FRAME,

PAINT SEE FINISH

DOOR, SEE DOOR

5 3/4"

3 INTERIOR HM HEAD TYP
SCALE: 3" = 1'-0"

EACH SIDE

SCHED.

SCHEDULE

FOR JAMB FRAMING

SEE STRUCT.

FOR WALL

Type A


CONSTRUCTION,

(3) METAL STUD ANCHORS &

(1) FLOOR ANCHOR PER JAMB

2 INTERIOR HM JAMB TYP
SCALE: 3" = 1'-0"

SEE SECTIONS

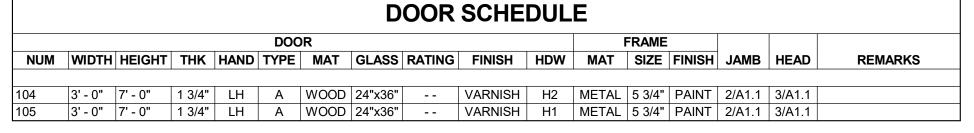

			ROO	M FIN	ISH S	CHED	ULE			
	ROOM INFORMATION		WALL	FINISHE	S	OTH	HER FINISH			
		NORTH	EAST	SOUTH	WEST	DAOE]
NUM	NAME	WALL	WALL	WALL WALL		BASE	FLOOR	TRIM	CEILING	NOTES
FIRST FL	OOR	<u>'</u>	1	ı					-I	
101	ENTRY		P1/WC1/WC3	P1	P1	B1	F2	P1	C1	SOFFIT TO BE P2
102	WORK AREA/ STORAGE	P2	P1	P1	P1		F2	P1	C1	
103	OPEN OFFICE	P1/WC2	P1	P2	P1	B1	F2	P1	C1	
104	BREAK/MEETING ROOM	P2	P1	P1	P1	B1	(E)	P1	C1	
105	OFFICE	P1	P1	P1	P1	B1	F2	P1	C1	
106	OFFICE	P1	P1	P1	P1	B1	F2	P1	C1	
107	OFFICE	P1	P1	P1	P1	B1	F2	P1	C1	
108	NEW SHARED OFFICE	P1	P1	P1	P1			P1		
109	STORAGE	P1	P1	P1	P1	B1		P1		
110	EXISTING OFFICE	P1	P1	P1	P1	B1		P1		
111	RECORDING					B1	F2	P1		
112	(E) MEN							P1		
113	(E) WOMEN							P1		
114	(E) STORAGE							P1		
115	(E) IT					-		P1		

• FINISI	ROOM FINISH LEGEND HES MARKED WITH THE P1 SYMBOL REFER TO THE FINISHES LISTED BELOW.
	LANS, ELEVATIONS, SECTIONS, AND DETAILS FOR SPECIFIC LOCATIONS OF HES LISTED.
SEE SCOLO	PECIFICATIONS FOR FULL DESCRIPTION OF FINISHES AND APPLICATIONS. RS OR FINISHES NOT SPECIFIED TO BE SELECTED BY ARCHITECT OR OWNER'S REP MANUFACTURER'S STANDARD COLORS.
BASE (B):
B1	TARKETT. RUBBER BASE. BASEWORKS THERMOSET RUBBER (TYPE TS) 4", COLOR: GATEWAY, TA4
CEILING	<u>(C)</u> :
C1	TILE: ARMSTRONG, 2'x2', FINE FISSURED, SQUARE EDGE, COLOR: WHITE GRID: ARMSTRONG, PRELUDE XL HEAVY DUTY, COLOR: WHITE
CORNE	R GUARDS: (CG)
CG1	INPRO ARCHITECTUAL PRODUCTS. CORNER GUARDS. 130 HIGH IMPACT CORNER GUARD. COLOR: TAUPE #0113. INSTALL @ ALL OUTSIDE CORNERS IN ROOMS RECEIVING NEW FINISHES.
<u>FLOORI</u>	NG (F):
FLOORI	NG (F): PATCRAFT. WALK - OFF CARPET. ON THE RIGHT FOOT 10305. COLOR: STERLING 00500
F1	PATCRAFT. WALK - OFF CARPET. ON THE RIGHT FOOT 10305. COLOR: STERLING 00500 PATCRAFT. FIELD CARPET. STATES OF WATER. GLACIAL ICE 10577. COLOR: DEW 00350
F1 F2	PATCRAFT. WALK - OFF CARPET. ON THE RIGHT FOOT 10305. COLOR: STERLING 00500 PATCRAFT. FIELD CARPET. STATES OF WATER. GLACIAL ICE 10577. COLOR: DEW 00350
F1 F2 PAINT (I	PATCRAFT. WALK - OFF CARPET. ON THE RIGHT FOOT 10305. COLOR: STERLING 00500 PATCRAFT. FIELD CARPET. STATES OF WATER. GLACIAL ICE 10577. COLOR: DEW 00350 P: SHERWIN WILLIAMS. INTERIOR PAINT. FIELD PAINT, DOOR AND WINDOW TRIM. COLOR:
F1 F2 PAINT (I	PATCRAFT. WALK - OFF CARPET. ON THE RIGHT FOOT 10305. COLOR: STERLING 00500 PATCRAFT. FIELD CARPET. STATES OF WATER. GLACIAL ICE 10577. COLOR: DEW 00350 SHERWIN WILLIAMS. INTERIOR PAINT. FIELD PAINT, DOOR AND WINDOW TRIM. COLOR: ANEW GRAY #SW 7030. SHERWIN WILLIAMS. INTERIOR PAINT. ACCENT PAINT. COLOR MATCH TO BLUE LOGO. COORDINATION WITH OWNER AND REFER TO THE MONTANA FISH WILLIAMS.
F1 F2 PAINT (I	PATCRAFT. WALK - OFF CARPET. ON THE RIGHT FOOT 10305. COLOR: STERLING 00500 PATCRAFT. FIELD CARPET. STATES OF WATER. GLACIAL ICE 10577. COLOR: DEW 00350 SHERWIN WILLIAMS. INTERIOR PAINT. FIELD PAINT, DOOR AND WINDOW TRIM. COLOR: ANEW GRAY #SW 7030. SHERWIN WILLIAMS. INTERIOR PAINT. ACCENT PAINT. COLOR MATCH TO BLUE LOGO. COORDINATION WITH OWNER AND REFER TO THE MONTANA FISH WILDLIFE AND PARK BRAND BOOK.

FINISH, MATERIALS, AND FURNITURE NOTES

HUNTER DOUGLAS. APPLAUSE. LITERISE BOTTOM-UP. LEGENDS FABRIC. COLOR: PORCELAIN #401.

FURNITURE MARKED WITH A * IS EXISTING FURNITURE THAT IS MOVING FROM EXISTING OFFICE LOCATION TO THE NEW LOCATION.

ALL WINDOWS IN PROJECT. ROOMS: 101, 103, 105, 106, 107, 108, 110

BEFORE ROUGH IN.

- UNDERSIDE OF STRUCTURE

METAL RUNNER TRACK

- 5/8" TYPE "X" GWB TO 4"

- SUSPENDED CEILING

ABOVE CEILING

======

- METAL STUDS

- METAL RUNNER TRACK

@ 16" O.C.

FLOOR LINE

TYPE MF

FURNITURE MARKED WITH A # IS NEW FURNITURE THAT THE OWNER WILL NEED PROVIDED IN NEW

LOCATION. PLEASE COORDINATE WITH OWNER.

PAINT ALL EXISTING DOOR AND WINDOW FRAMES AND TRIM IN THE NEW CONSTRUCTION P1

ALL FURNITURE BY OWNER. PLEASE COORDINATE WITH OWNER ON LOCATION OF ELEC. AND DATA

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THIS PROJECT BEFORE FINAL PLACEMENT OF MATERIALS.

23-153-01 DRAWN BY MMA/MM **APPROVED** CWG **DATE** 10.18.21


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PARKS SE REM

% F

1, WILDLIFE, & TDOORS OFFICHELENA, MT 59602

REVISIONS

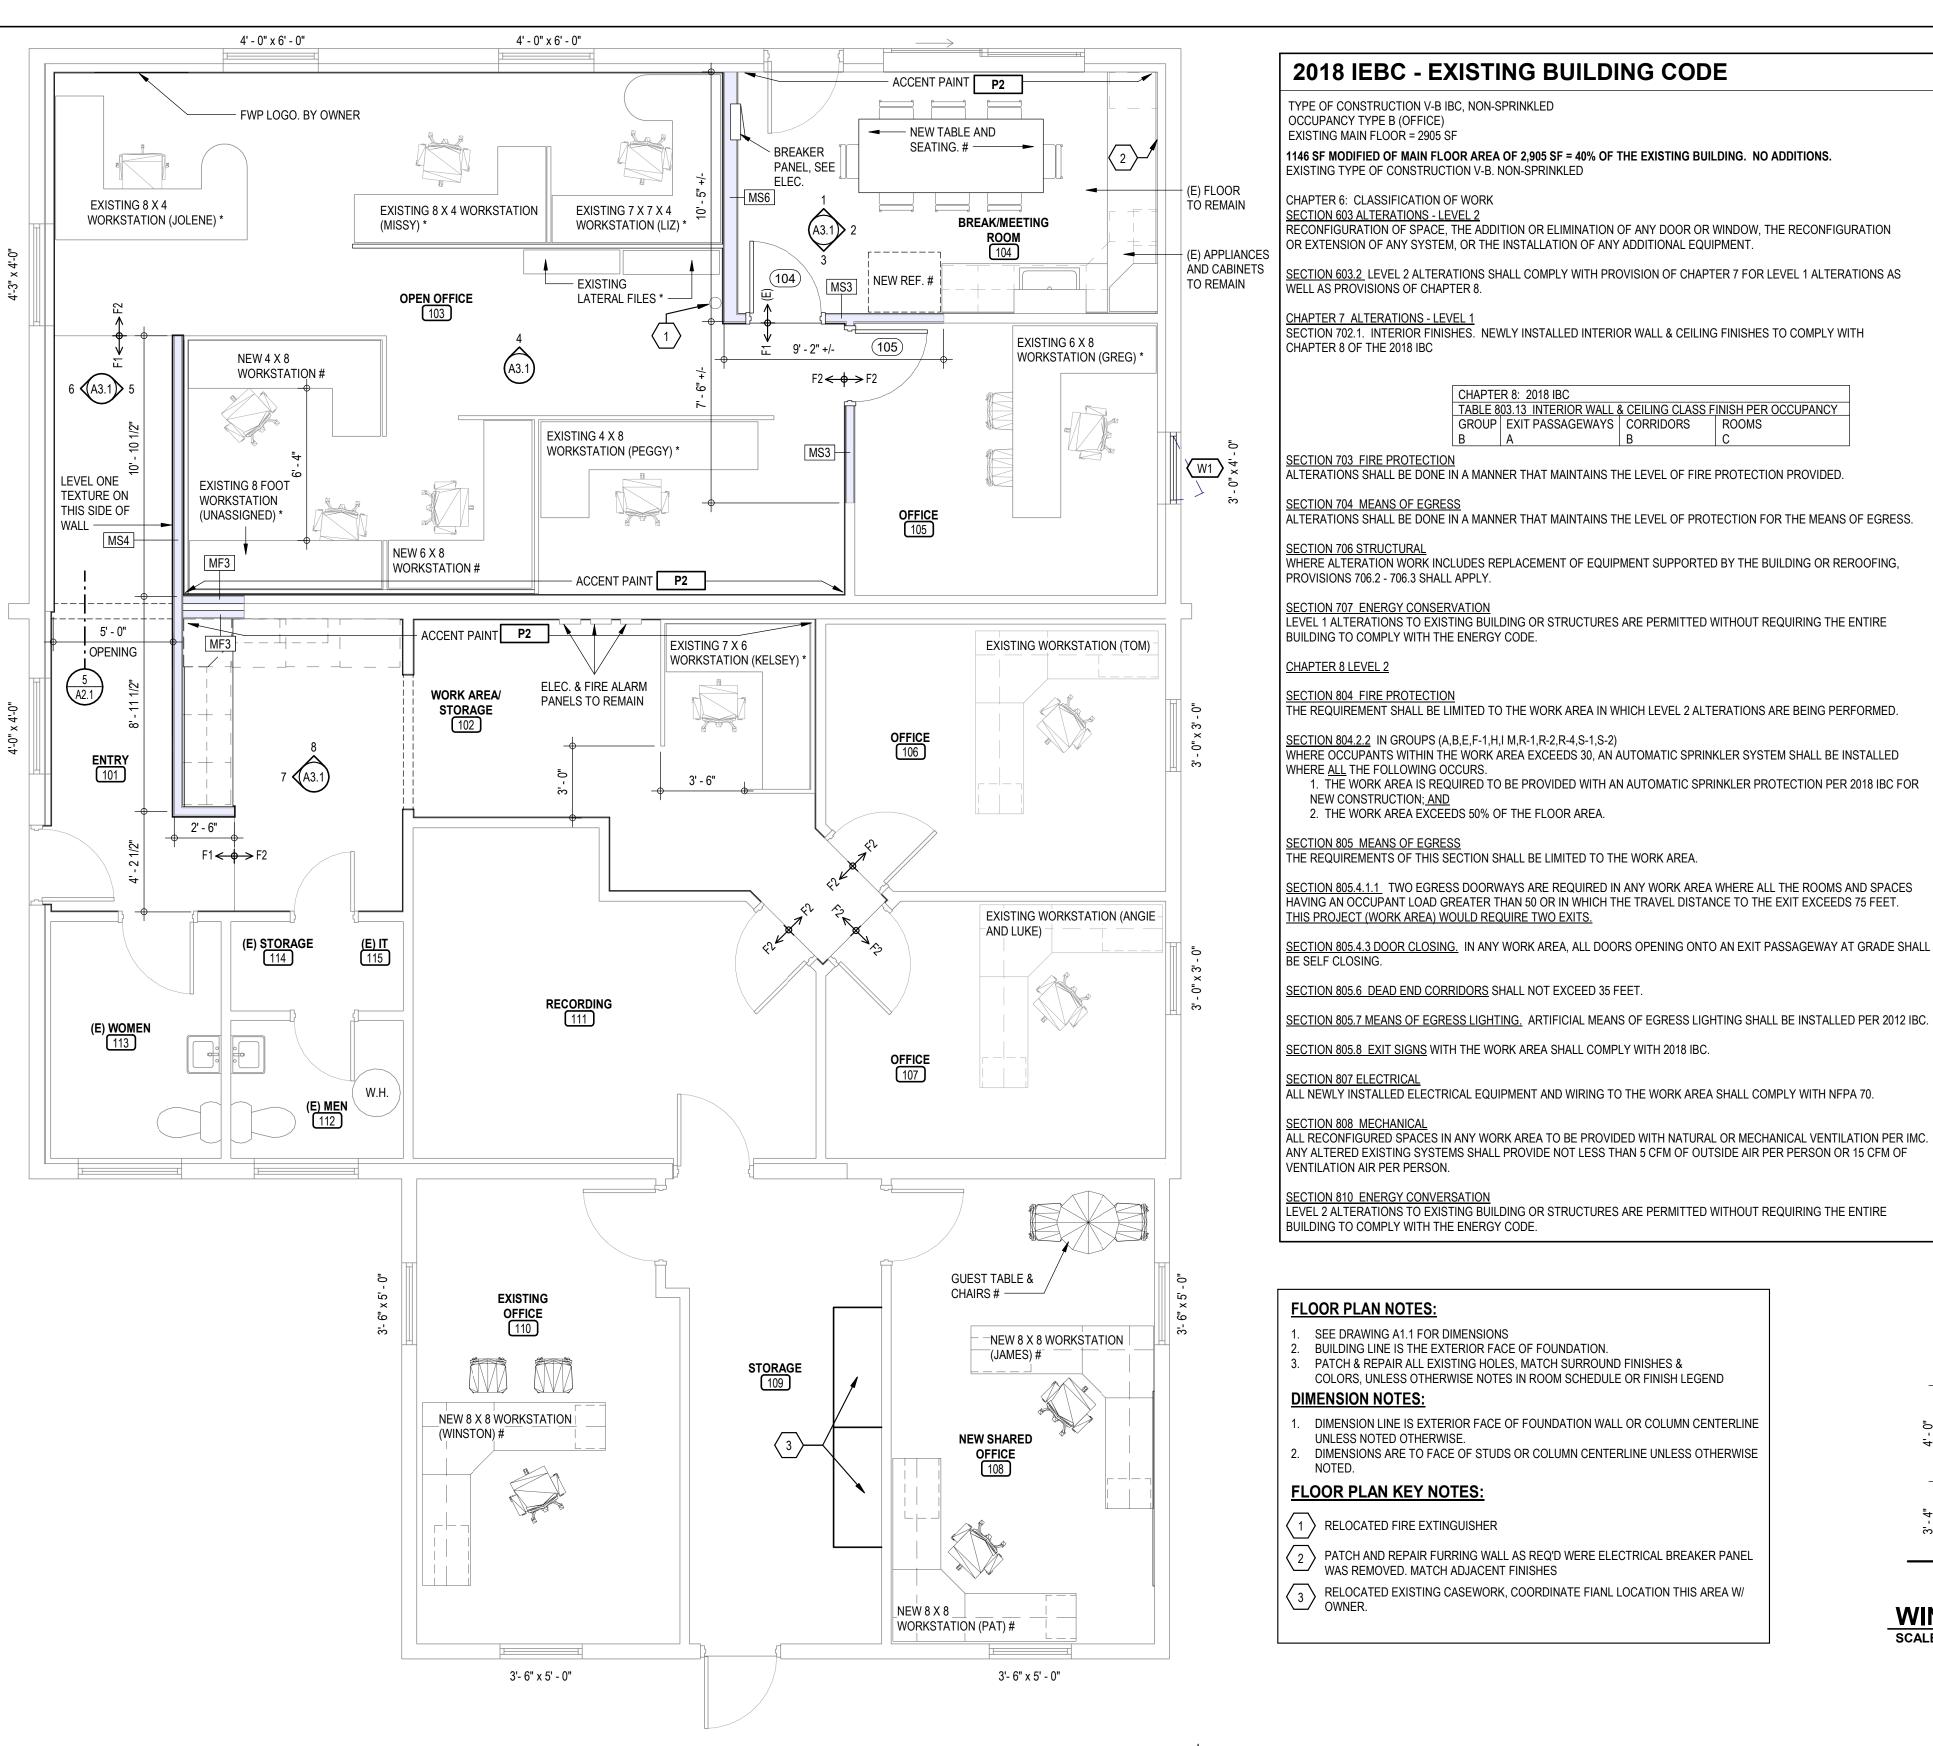

5/8" GYP. BD. RETURNS —

2X WOOD SILL PLATE -

EXISTING 2X WOOD

FURRED WALL TO REMAIN -

SCALE: 1 1/2" = 1'-0"

— P. LAM SILL PL2


- 1/2" BLOCKING

MATCH WINDOW

- EXISTING CMU WALL TO REMAIN

CLAD WOOD, SILL FRAME

- DRIP FLASHING, COLOR TO

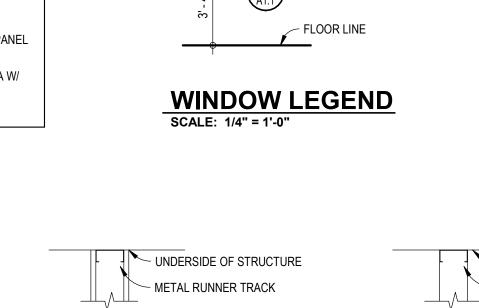

5/8" TYPE "X"

- METAL STUDS

@ 16" O.C.

FLOOR LINE

TYPE MS

MS4 3 5/8" METAL STUD

SCALE: 1" = 1'-0"


WALL LEGEND

SUSPENDED CEILING

- METAL RUNNER TRACK

MF3 3 1/2" METAL STUD

GWB

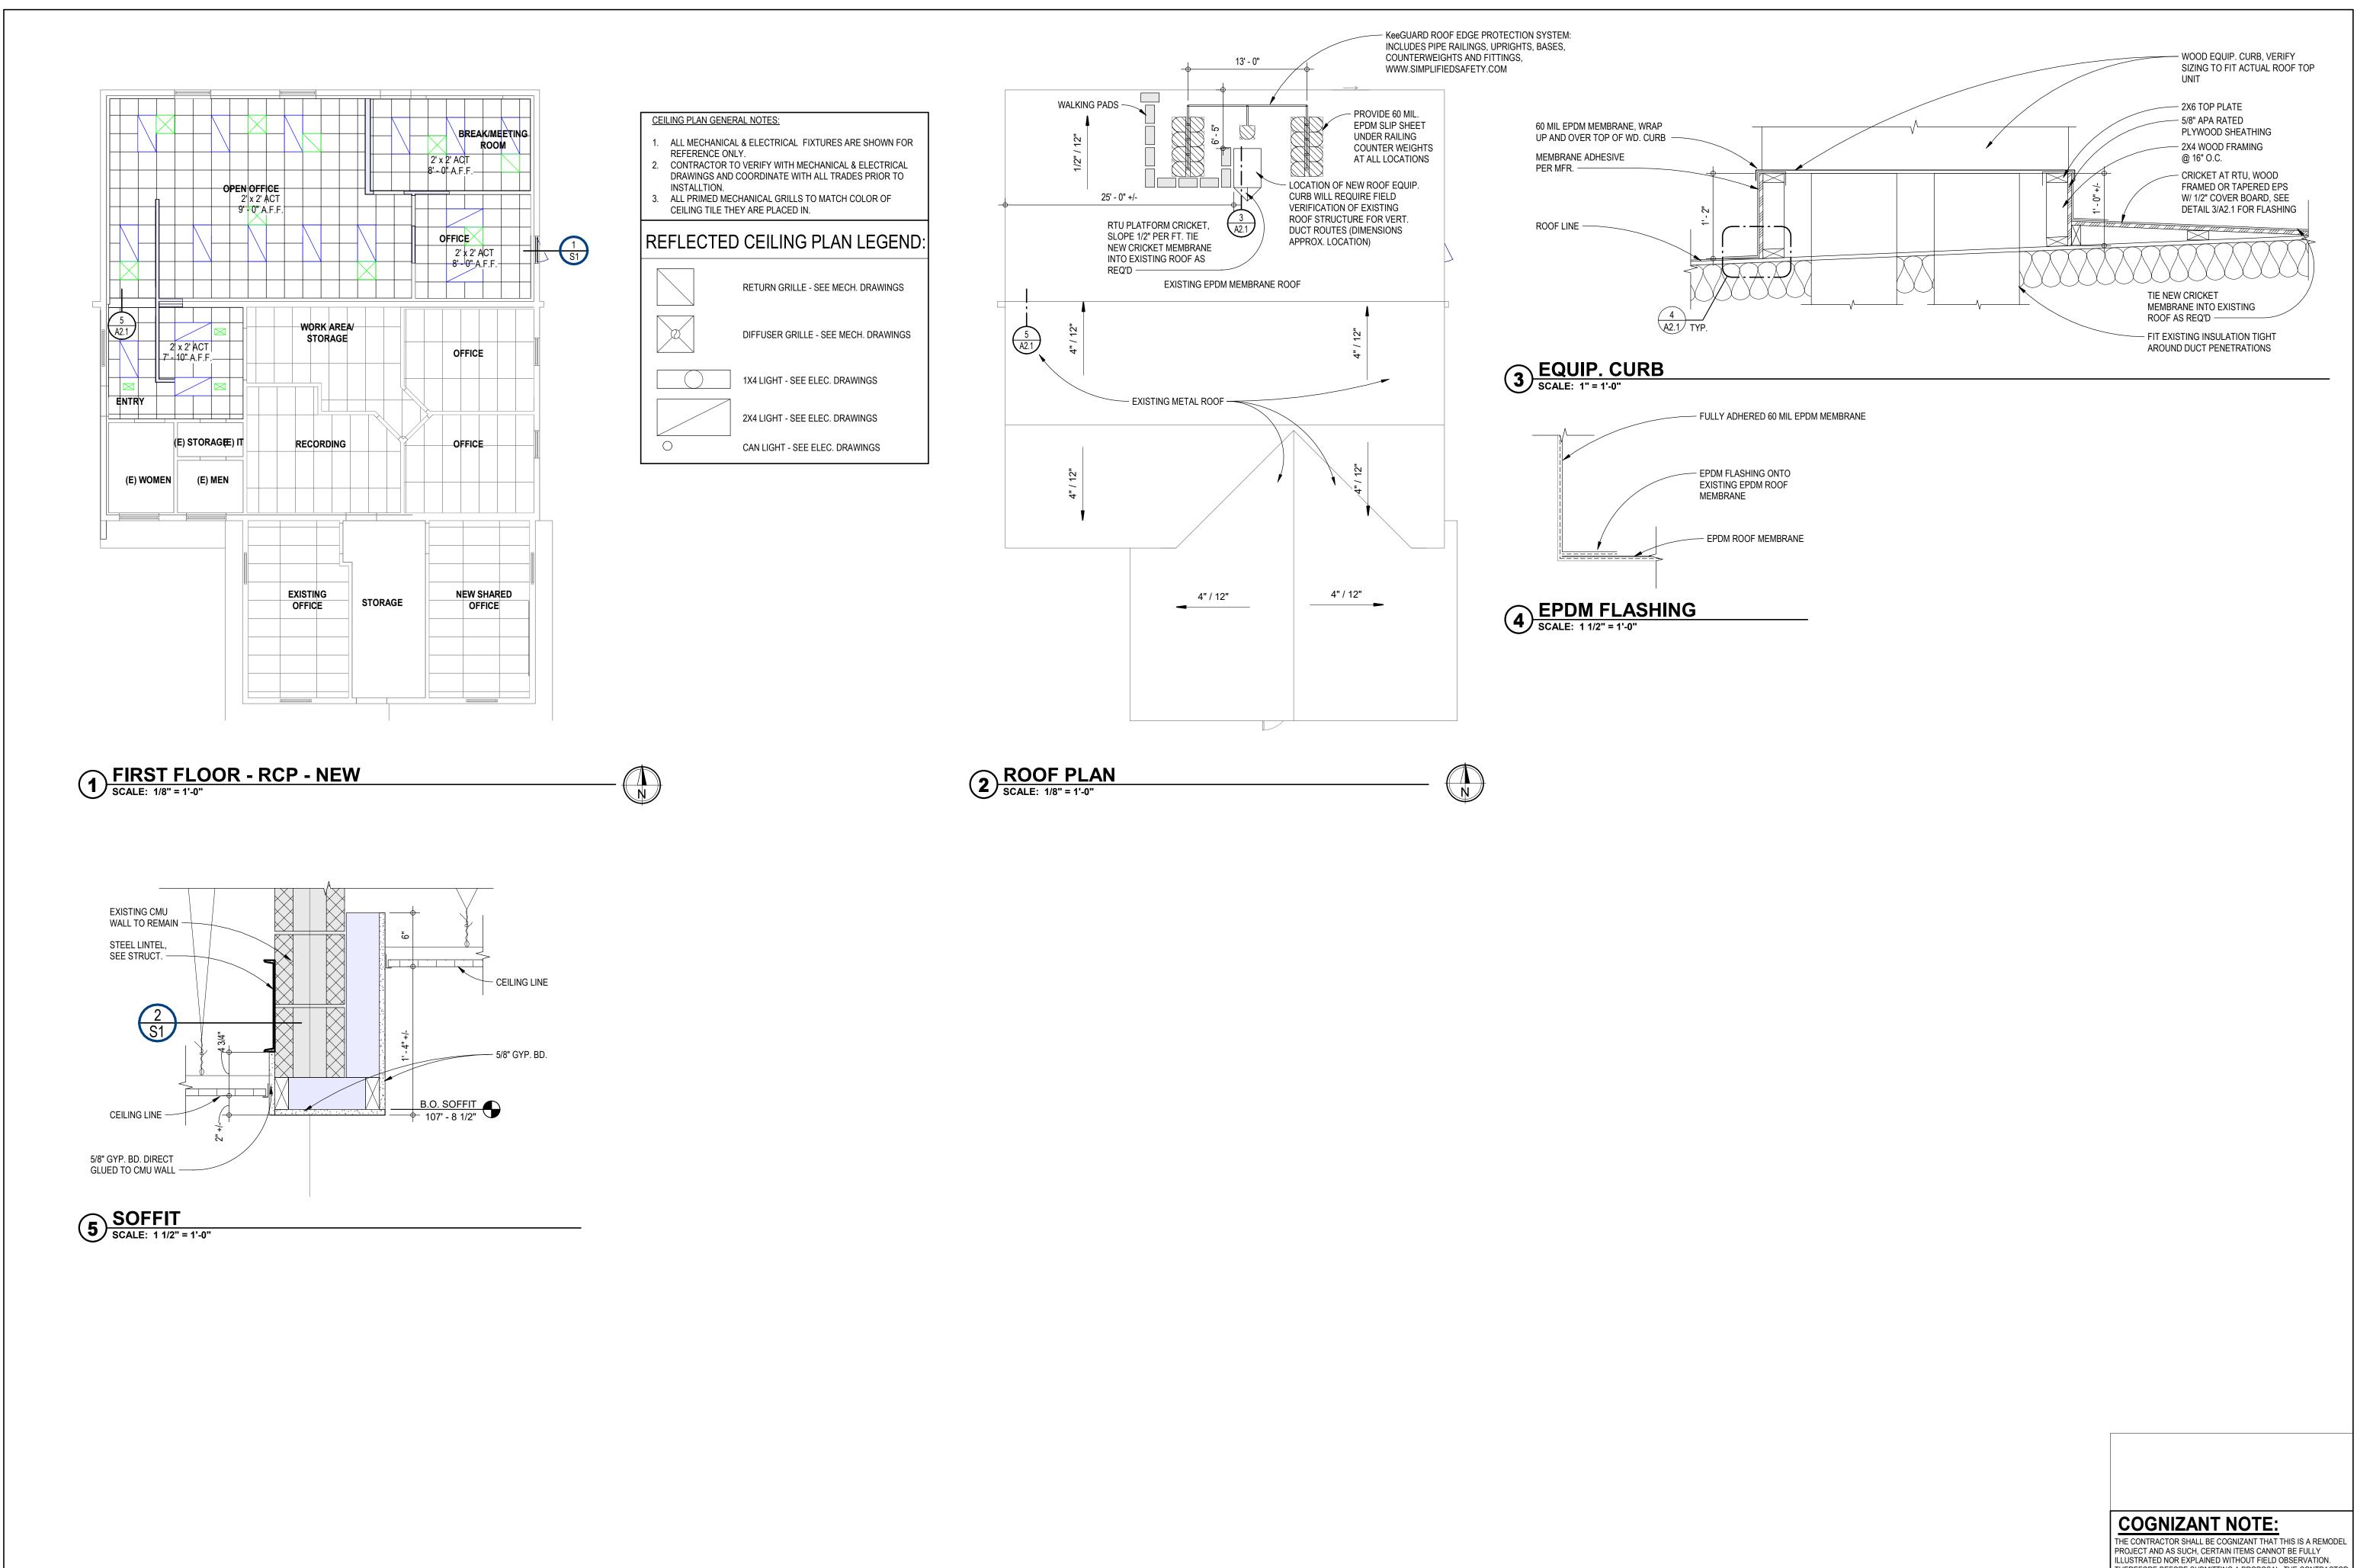

MONTANA FISH, WILDLIFE, & PARKS
MONTANA OUTDOORS OFFICE REMOD
930 CUSTER AVENUE, HELENA, MT 59602
REFLECTED CEILING PLAN

THEREFORE BEFORE SUBMITTING A PROPOSAL, THE CONTRACTOR SHALL VISIT AND EXAMINE THE PROJECT IN EVERY DETAIL AS PERTAINS TO THIS PROJECT AND MAKE ALLOWANCES IN THEIR PROPOSAL FOR ALL CONDITIONS THAT WILL AFFECT THE WORK INDICATED IN THE PROJECT MANUAL AND CONTRACT DOCUMENT


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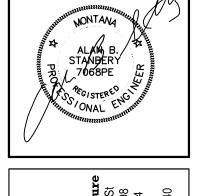
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23-153-01 DRAWN BY MMA APPROVED CWG **DATE** 10.18.21

REVISIONS

DATE





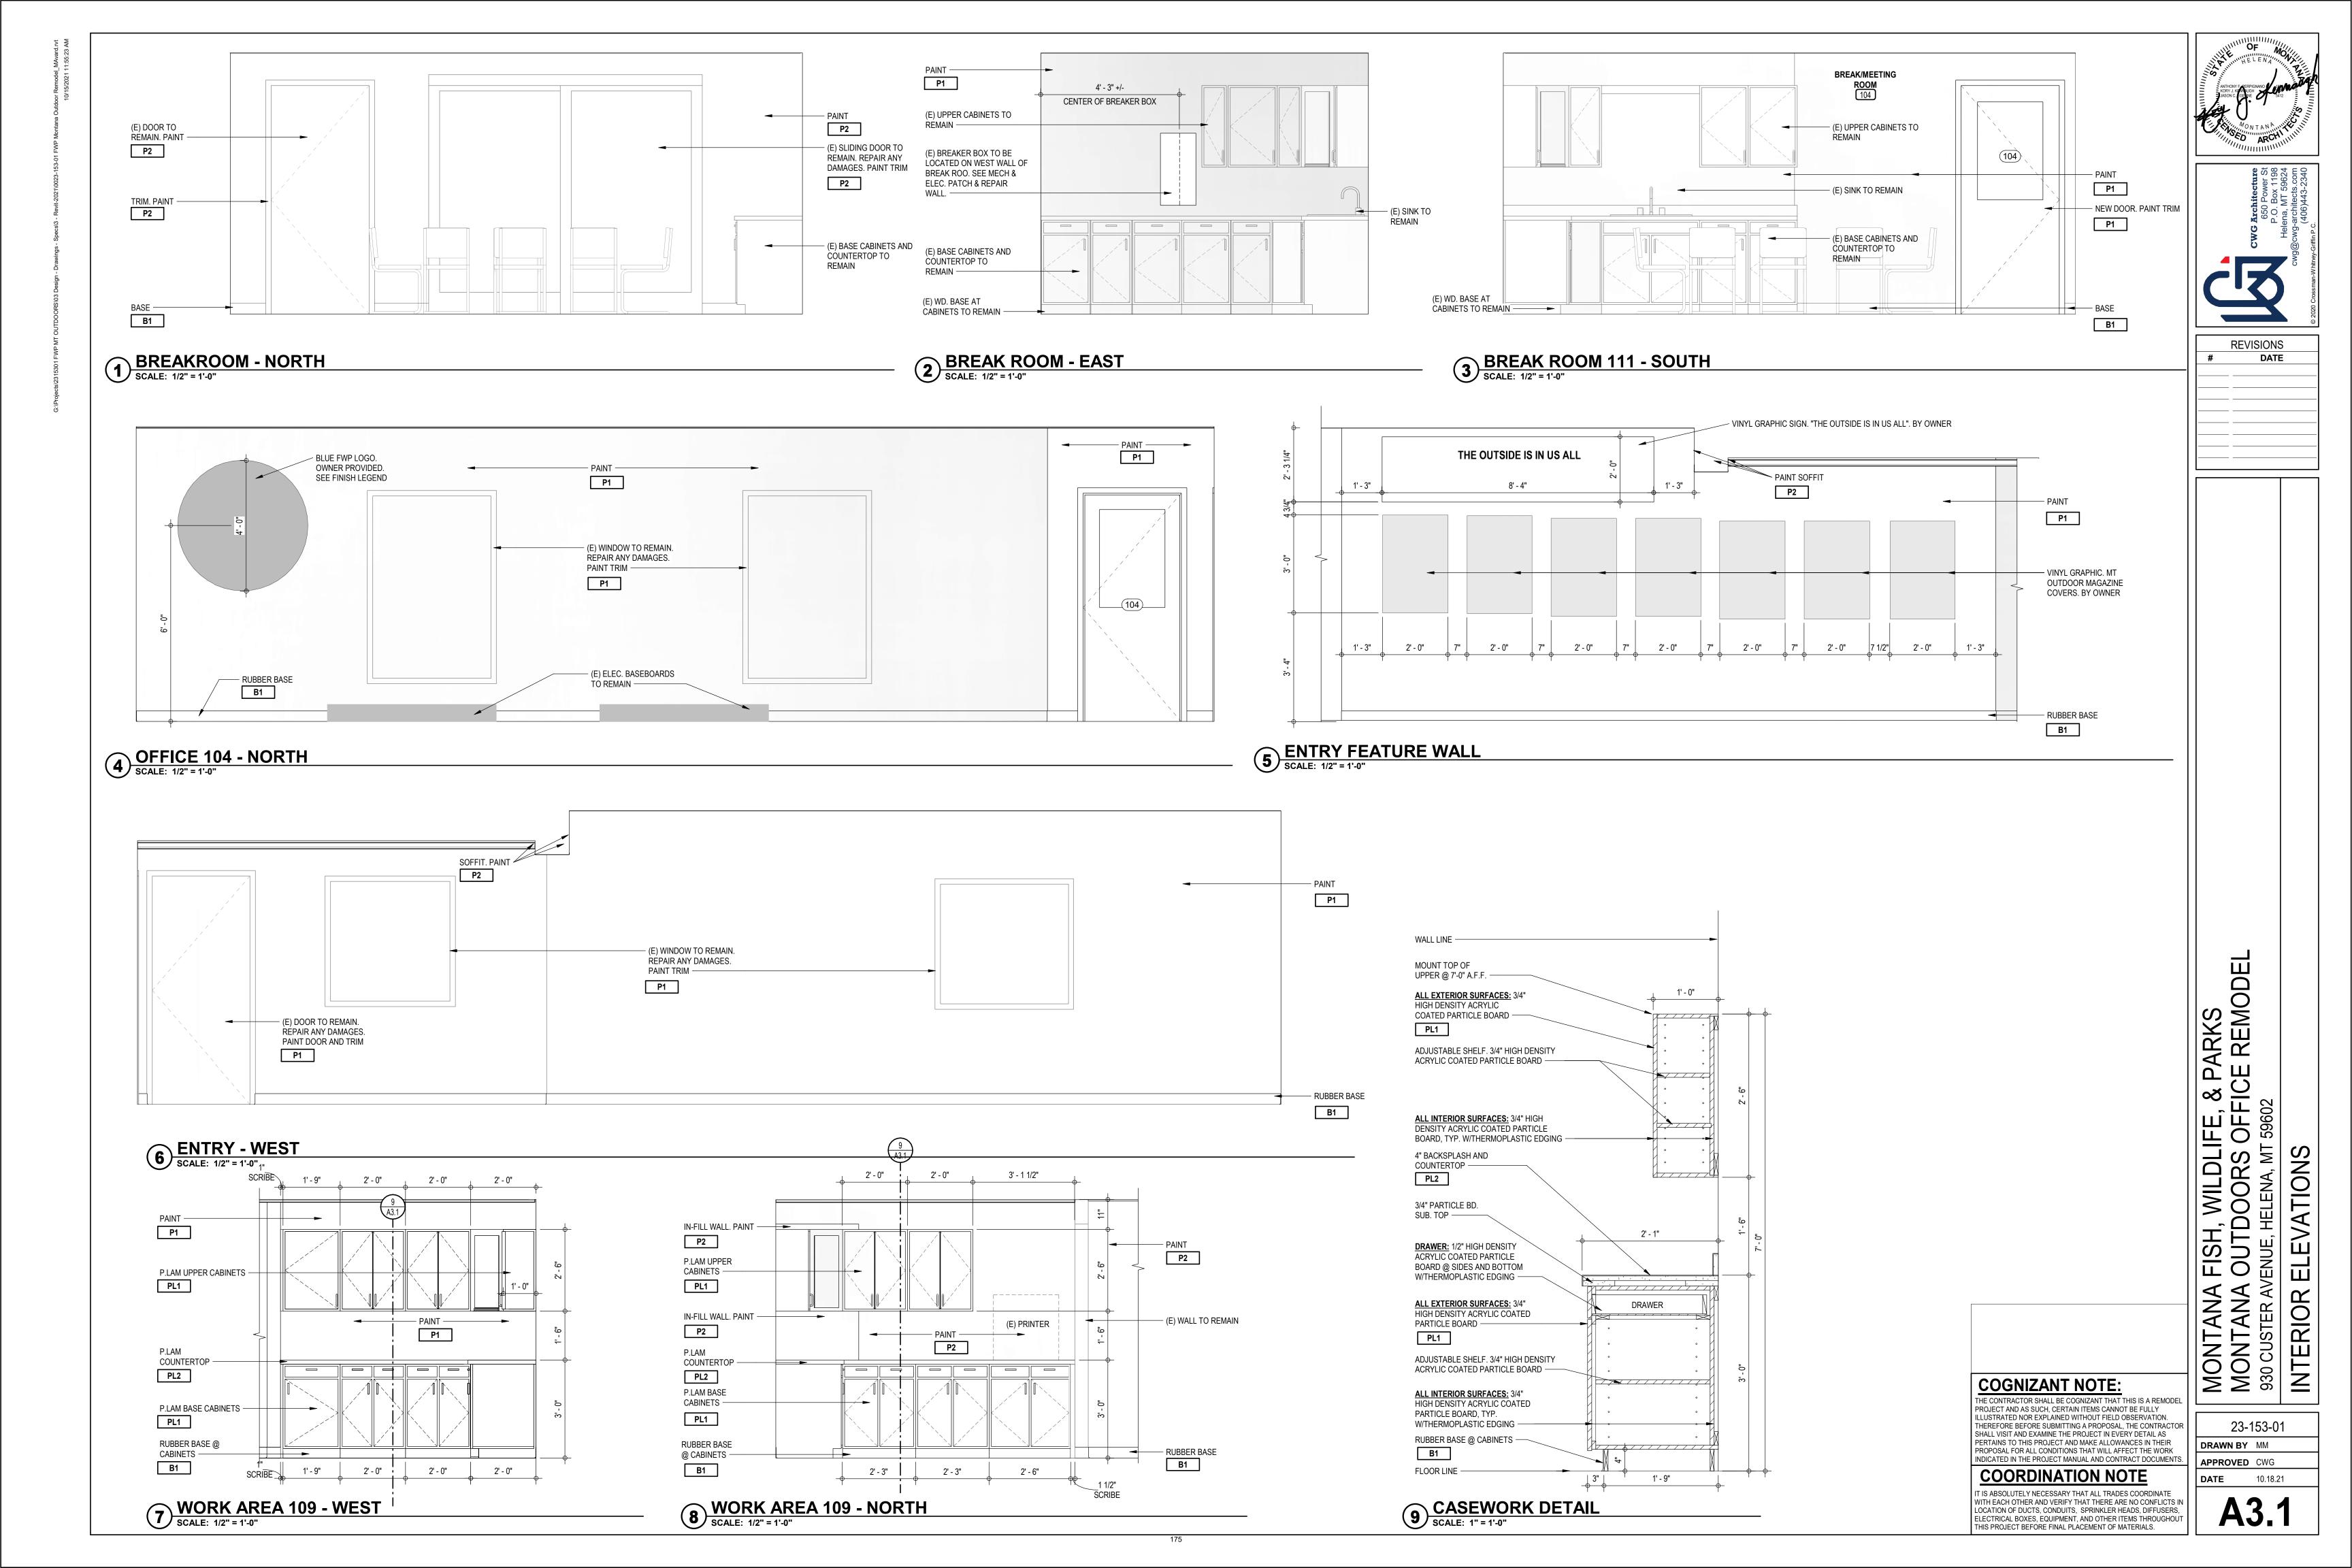

REVISIONS


DATE

1/2" DIA HILTI HIT HY70 BOLT (2"EMBEDMT) IN VERT PAIRS @16" MAX 、 MC12x10.6 @ INTER SIDE WALL 2-1/2" DIA HILTI HIT HY70 BOLTS (2"EMBEDMT) ELEV=SEE ARCH'L NEW OPNG FACE_ `EXIST CMU WALL EXIST 8"CMU WALL TO BE REMOVED \(\sime\) FOR NEW WINDOW, SEE ARCH'L CONN DETAIL @ EACH END NOTE: DO NOT OVERCUT NEW OPENING PAST THE ROUGH OPENING REQ'D EXIST 8"CMU WALL

NOTE: NEW CHNL HEADER MUST BE INSTALLED BEFORE REMOVING WALL SECTION


MONTANA FWP PROJECT # 7199172
MONTANA OUTDOORS OFFICE REMODEL
930 CUSTER AVE, HELENA, MT 59602
STRUCTURAL DETAILS

23-153-01 DRAWN ____ABS APPROVED ABS DATE <u>10/18/21</u>

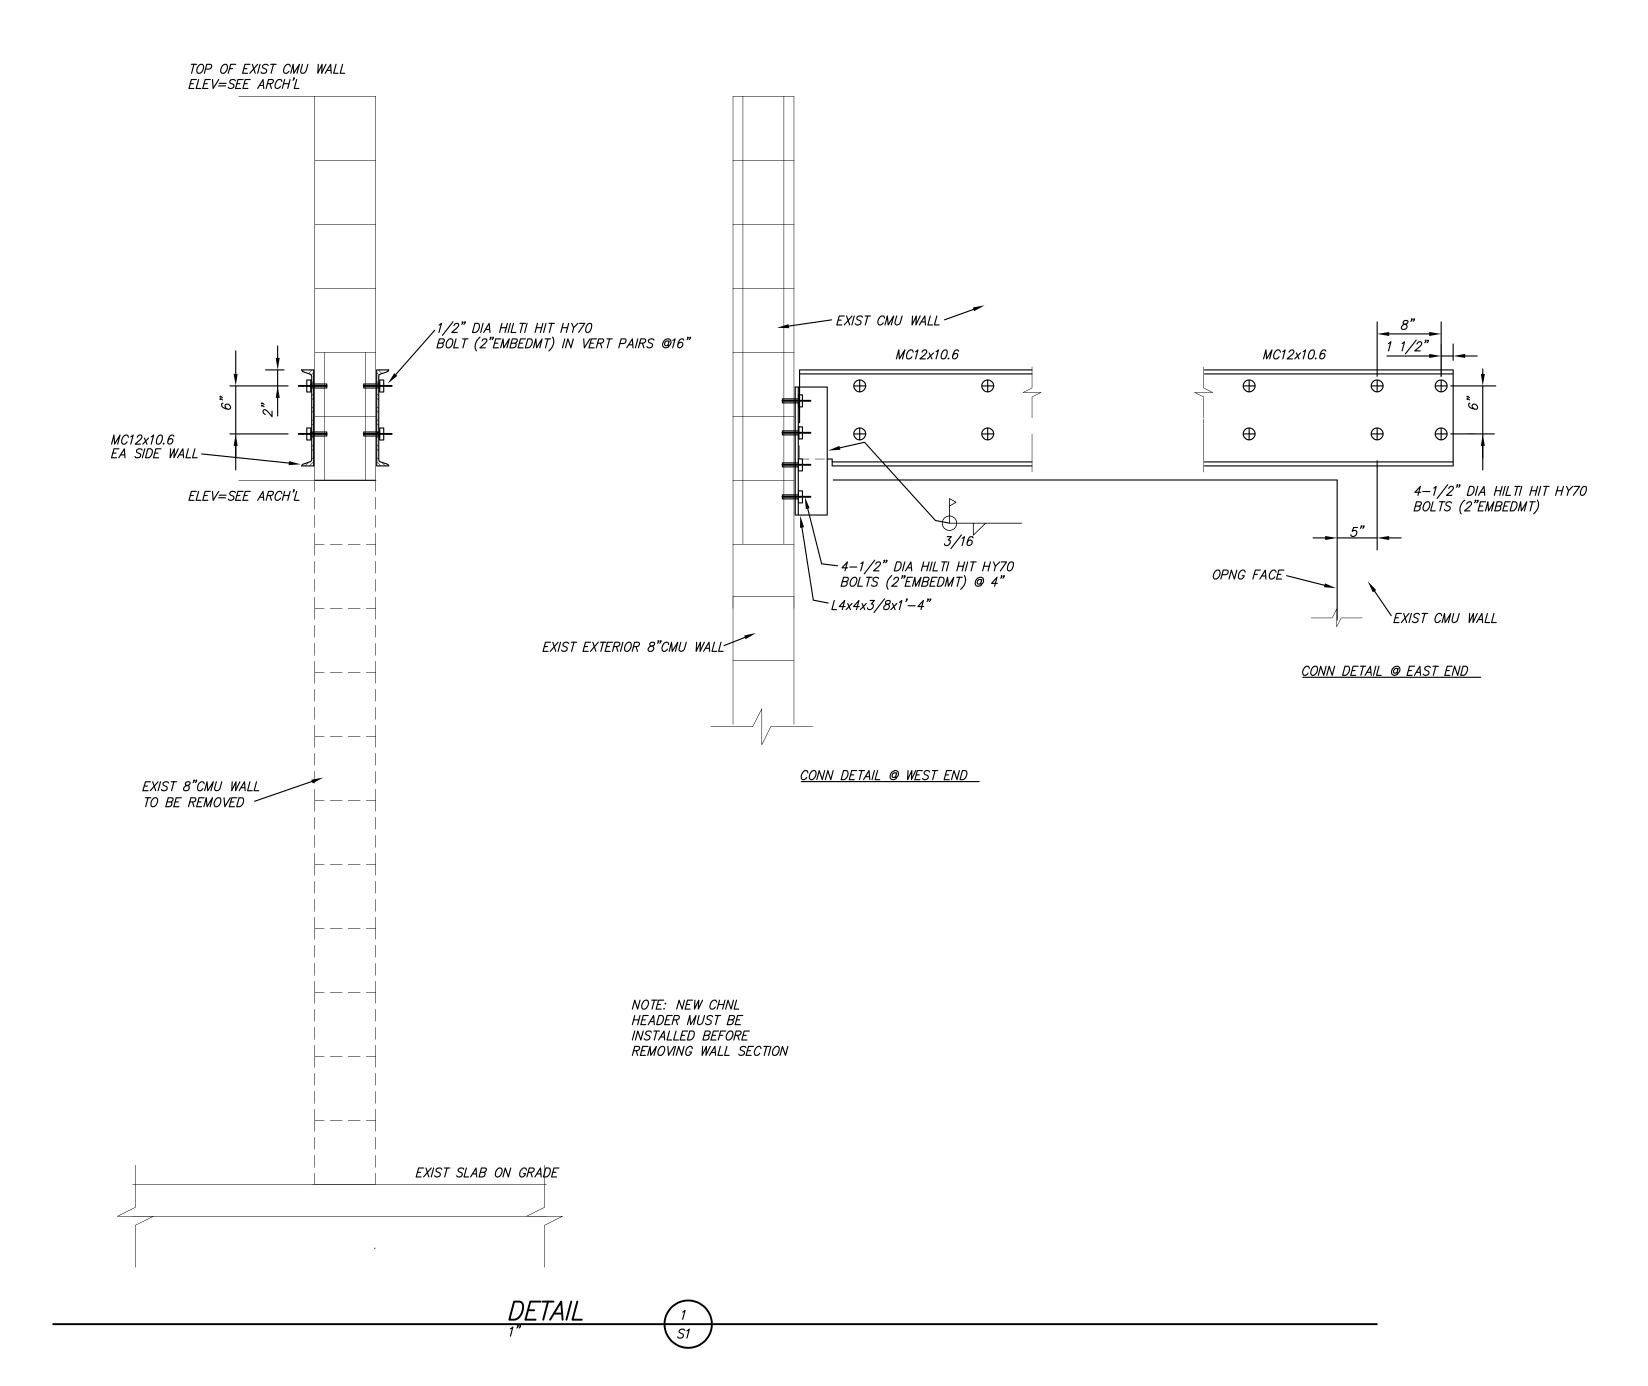



176

- 1 ELECTRIC BASEBOARD HEATER SHALL REMAIN IN SERVICE.
- CAP DUCT AT MAIN DUCT. REMOVE RUNOUT DUCT & GRILLE.
- RUNOUT DUCT TO THIS GRILLE SHALL REMAIN. REMOVE GRILLE & EXTEND DUCT AS REQUIRED FOR INSTALLATION OF NEW GRILLE.
- REMOVE DUCT UP THROUGH ROOF STRUCTURE. HORIZONTAL DUCT SHALL REMAIN.
- REMOVE CEILING RETURN GRILLE & DUCT UP THROUGH ROOF STRUCTURE.
- REMOVE EXISTING ROOFTOP UNIT RTU-1(D) & DUCTWORK ON ROOF. OPENINGS THROUGH ROOF STRUCTURE TO REMAIN. PREPARE ROOF FOR INSTALLATION OF NEW PLATFORM & RTU.
- $\overline{7}$ REMOVE WALL MOUNTED THERMOSTAT SERVING RTU-1(D).
- CAP HW, CW PIPING IN WALL. ALL PIPING SERVING EXISTING FUNCTIONAL SINK SHALL REMAIN IN SERVICE.
- 9 DEMO EXHAUST DUCT AND GRILLES IN THEIR ENTIRETY.
- DEMO EXISTING EXHAUST FAN, REMOVE ELECTRICAL AND CONTROLS BACK TO NEAREST JUNCTION BOX.
- ABANDON LOUVER IN PLACE. CAP AND SEAL INTERIOR OF LOUVER AS PER DETAIL 2/M-1.
- (12) VERIFY ROUTING OF DUCT RUNOUT SERVING THIS GRILLE. DEMO AND CAP IN APPROPRIATE LOCATION.

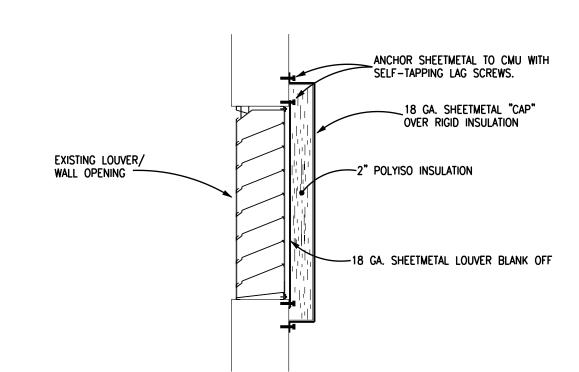



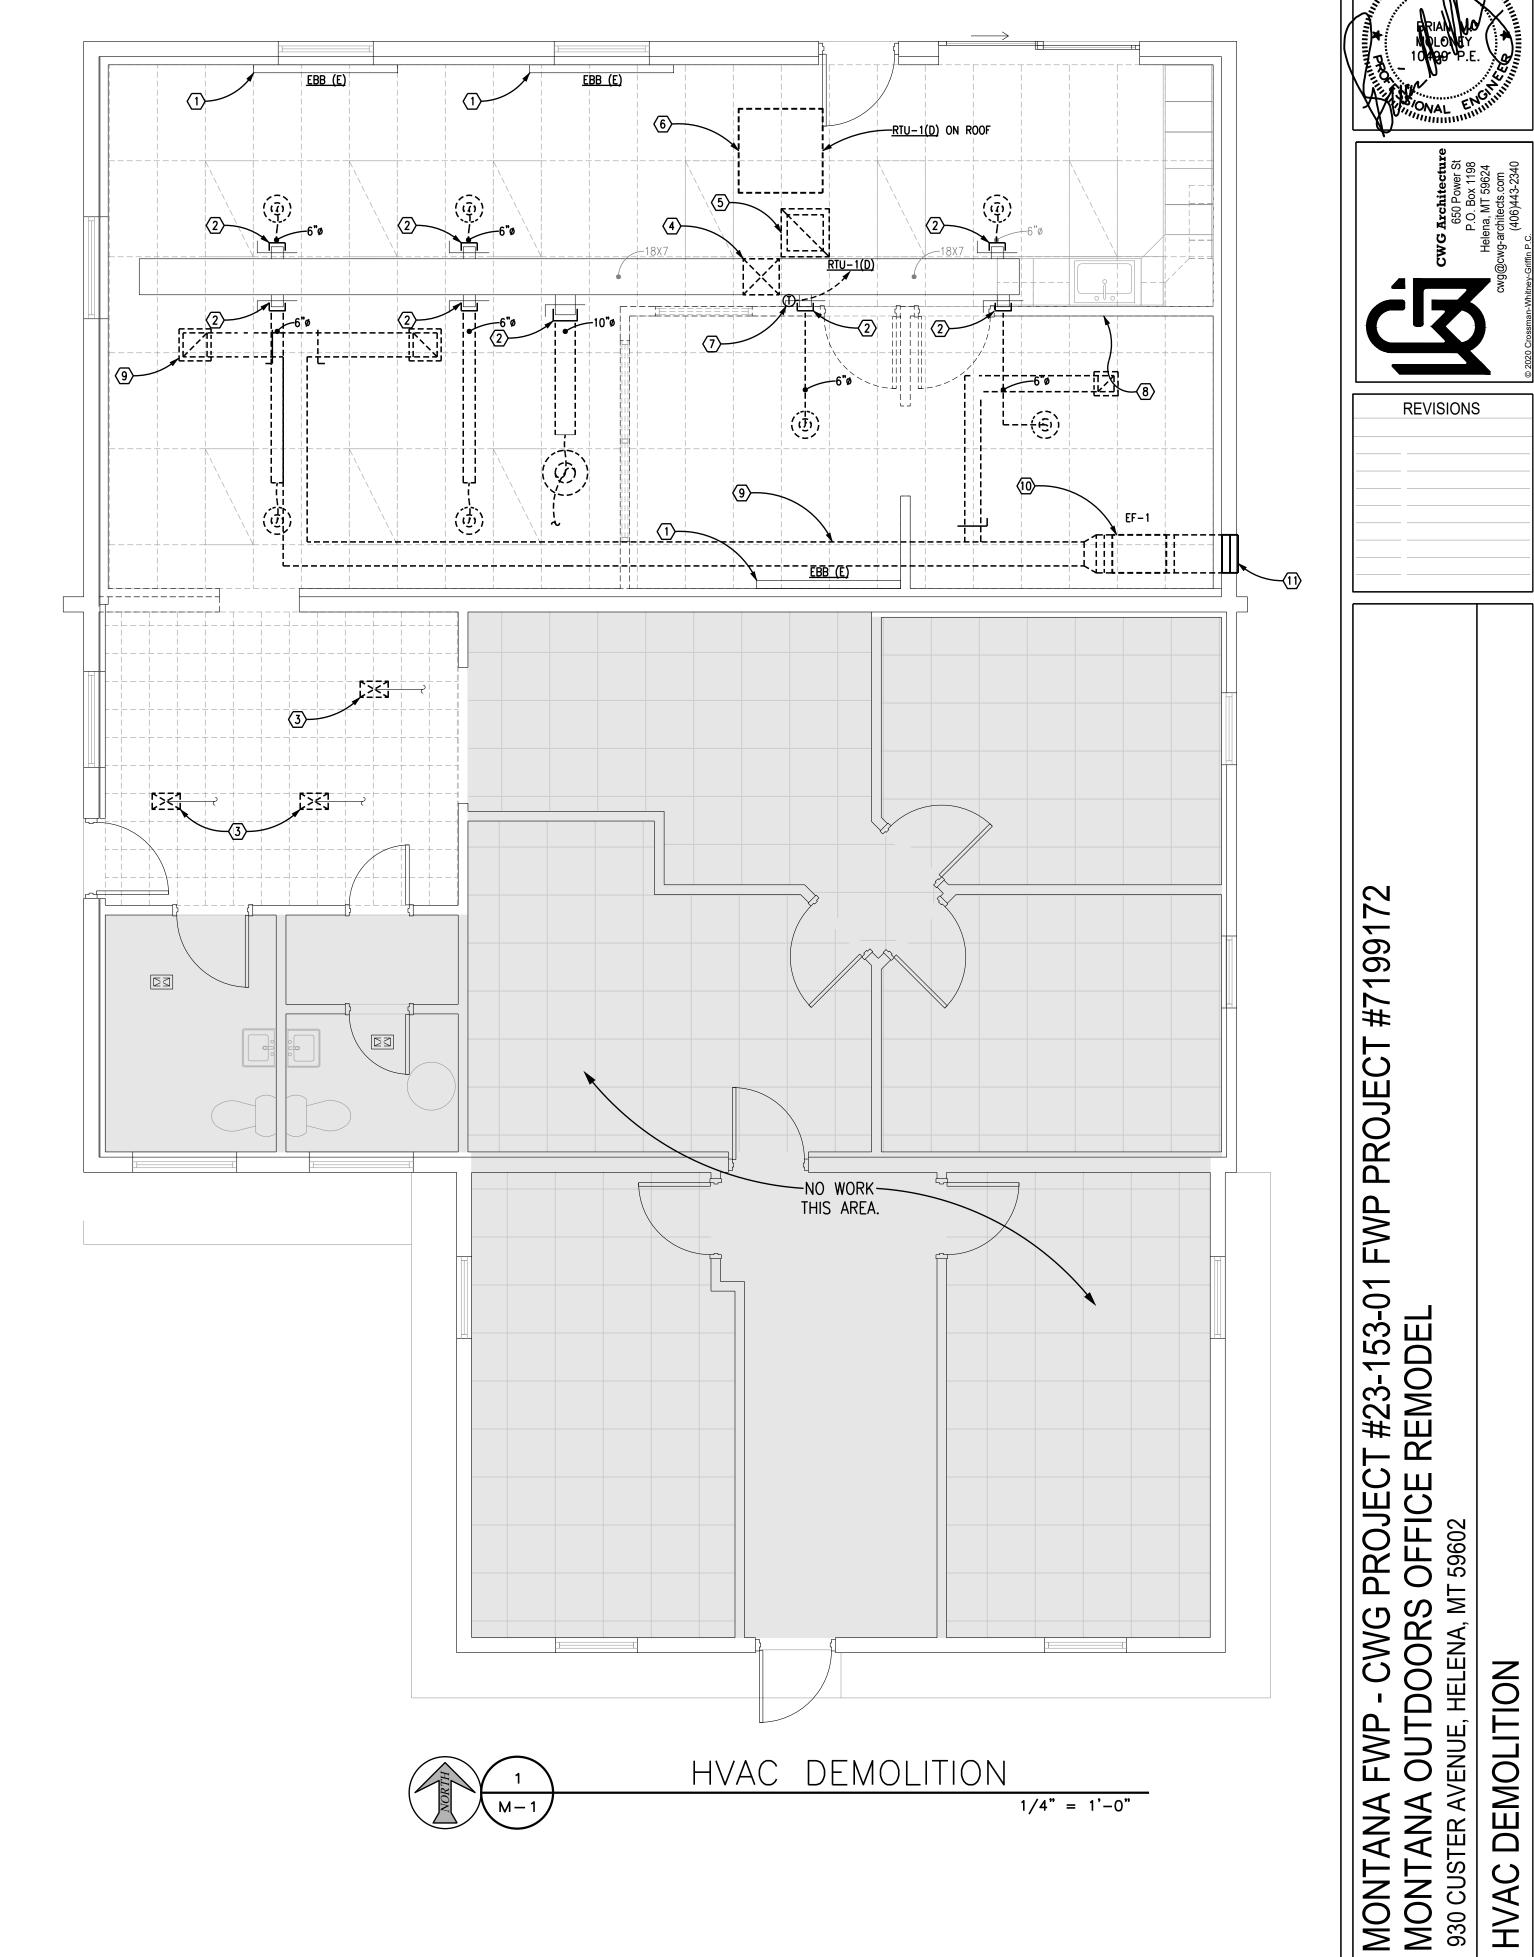

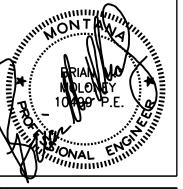

REVISIONS

23-153-01 10.18.2021 **M-1**

WORK NOTES:


- WALL PARTITION FRAMING SHALL BE CUT OUT AROUND DUCTWORK IN THIS AREA. BRACE WALL PARTITION TO ROOF STRUCTURE OUTSIDE OF THIS AREA.
- FURNISH & INSTALL RTU-1(N) ON PLATFORM. CONSTRUCT PLATFORM AS PER ARCHITECTURAL PLANS. DO NOT CUT ANY STRUCTURAL MEMBERS.
- 3 12x16 DUCT THROUGH EXISTING ROOF PENETRATION TO RTU-1(N) ON PLATFORM ABOVE.
- 10x16 DUCT THROUGH EXISTING ROOF PENETRATION TO RTU-1(N) ON PLATFORM ABOVE.
- (5) CONNECT NEW DUCT RUNOUT TO EXISTING MAIN DUCT.
- EXTEND/MODIFY DUCT AS NECESSARY FOR INSTALLATION OF NEW CEILING. FURNISH & INSTALL NEW CEILING GRILLE. VERIFY GRILLE SIZE PRIOR TO ORDERING.
- FURNISH & INSTALL NEW ELECTRIC BASEBOARD HEATER ON WALL. INSTALL HEATER IN LOCATION SUCH THAT NEW WIRING SERVING HEATER CAN BE ROUTED IN NEW PARTITION WALLS.
- FURNISH & INSTALL NEW WALL MOUNTED THERMOSTAT SERVING RTU-1(N).

- 9 12X16 RETURN AIR DUCT FROM BELOW. OFFSET DUCT IN RAISED PLATFORM.
- 10 10x16 UP TO RTU-1(N). SEE 1/M-2 FOR CONTINUATION.
- 10x16 SUPPLY AIR DUCT DOWN THROUGH PLATFORM. SEE 1/M-2 FOR CONTINUATION.
- (12) INSTALL EBB-6 SO IT DOES NOT INTERFERE WITH SWING OF DOOR OR OBSTRUCT ACCESS TO ELECTRICAL PANEL.

		<u>AL</u>	TERN	IATE	BID j	#2: R0	OOFTC	P UNIT SO	CHEDU	<u>LE</u>	
MARK	MANUFACTURER	MODEL	<u>CFM</u>	ESP	FAN HP	HEA	TING	NOMINAL COOLING (TONS)	VOLT/PH	MCA/MOCP	ACCESSORIES AND NOTES
						INPUT MBH	OUTPUT MBH	SEER / SEER			
<u>RTU-1(N)</u>	FRASER-JOHNSTON	PCG4A300502X4	1090	0.5	0.33	-	-	2.5 / 14.0 SEER	230/1	18.8/30	1
1 WITH	H VARIABLE SPEED HIG	SH STATIC MOTOR, HUI	RRICANE K	IT. ANCHO	OR UNIT T	O NEW PLA	TFORM, SEE	ARCHITECTURAL PL	ANS.	1	

			GRILL	E AND	REGISTI	ER SCHED	ULE		
MARK	MANUFACTURER	MODEL	TYPE	MATERIAL	FINISH	ACCESSORIES	BORDER	FASTENING	THROW
S-1	NAILOR	7500	MOD. CORE SUPPLY	STEEL	WHITE	-	TYPE L	LAY IN	MODULAR CORE 4-WAY
R-1	NAILOR	61EC	EGGCRATE RETURN	STEEL	WHITE	-	TYPE PLS	LAY IN	-

				ELEC	TRIC B	ASEBO,	ARD SCHE	DULE		
MARK	MFGR	CATALOG NO.	TYPE	<u>LENGTH</u>	BTU/HR	WATTS	VOLTS/PHASE	AMPS	CONTROL	NOTES
EBB-4	OUELLET	OLDU1002-HA	BASEBOARD	50"	3412	1000	120/1	8.3	INTEGRAL T-STAT	①
EBB-5	OUELLET	OLDU1002-HA	BASEBOARD	50"	3412	1000	120/1	8.3	INTEGRAL T-STAT	①
<u>EBB-6</u>	OUELLET	OLDU0752-HA	BASEBOARD	40"	2559	750	120/1	6.3	INTEGRAL T-STAT	①
<u>EBB-7</u>	OUELLET	OLDU1002-HA	BASEBOARD	50"	3412	1000	120/1	8.3	INTEGRAL T-STAT	①

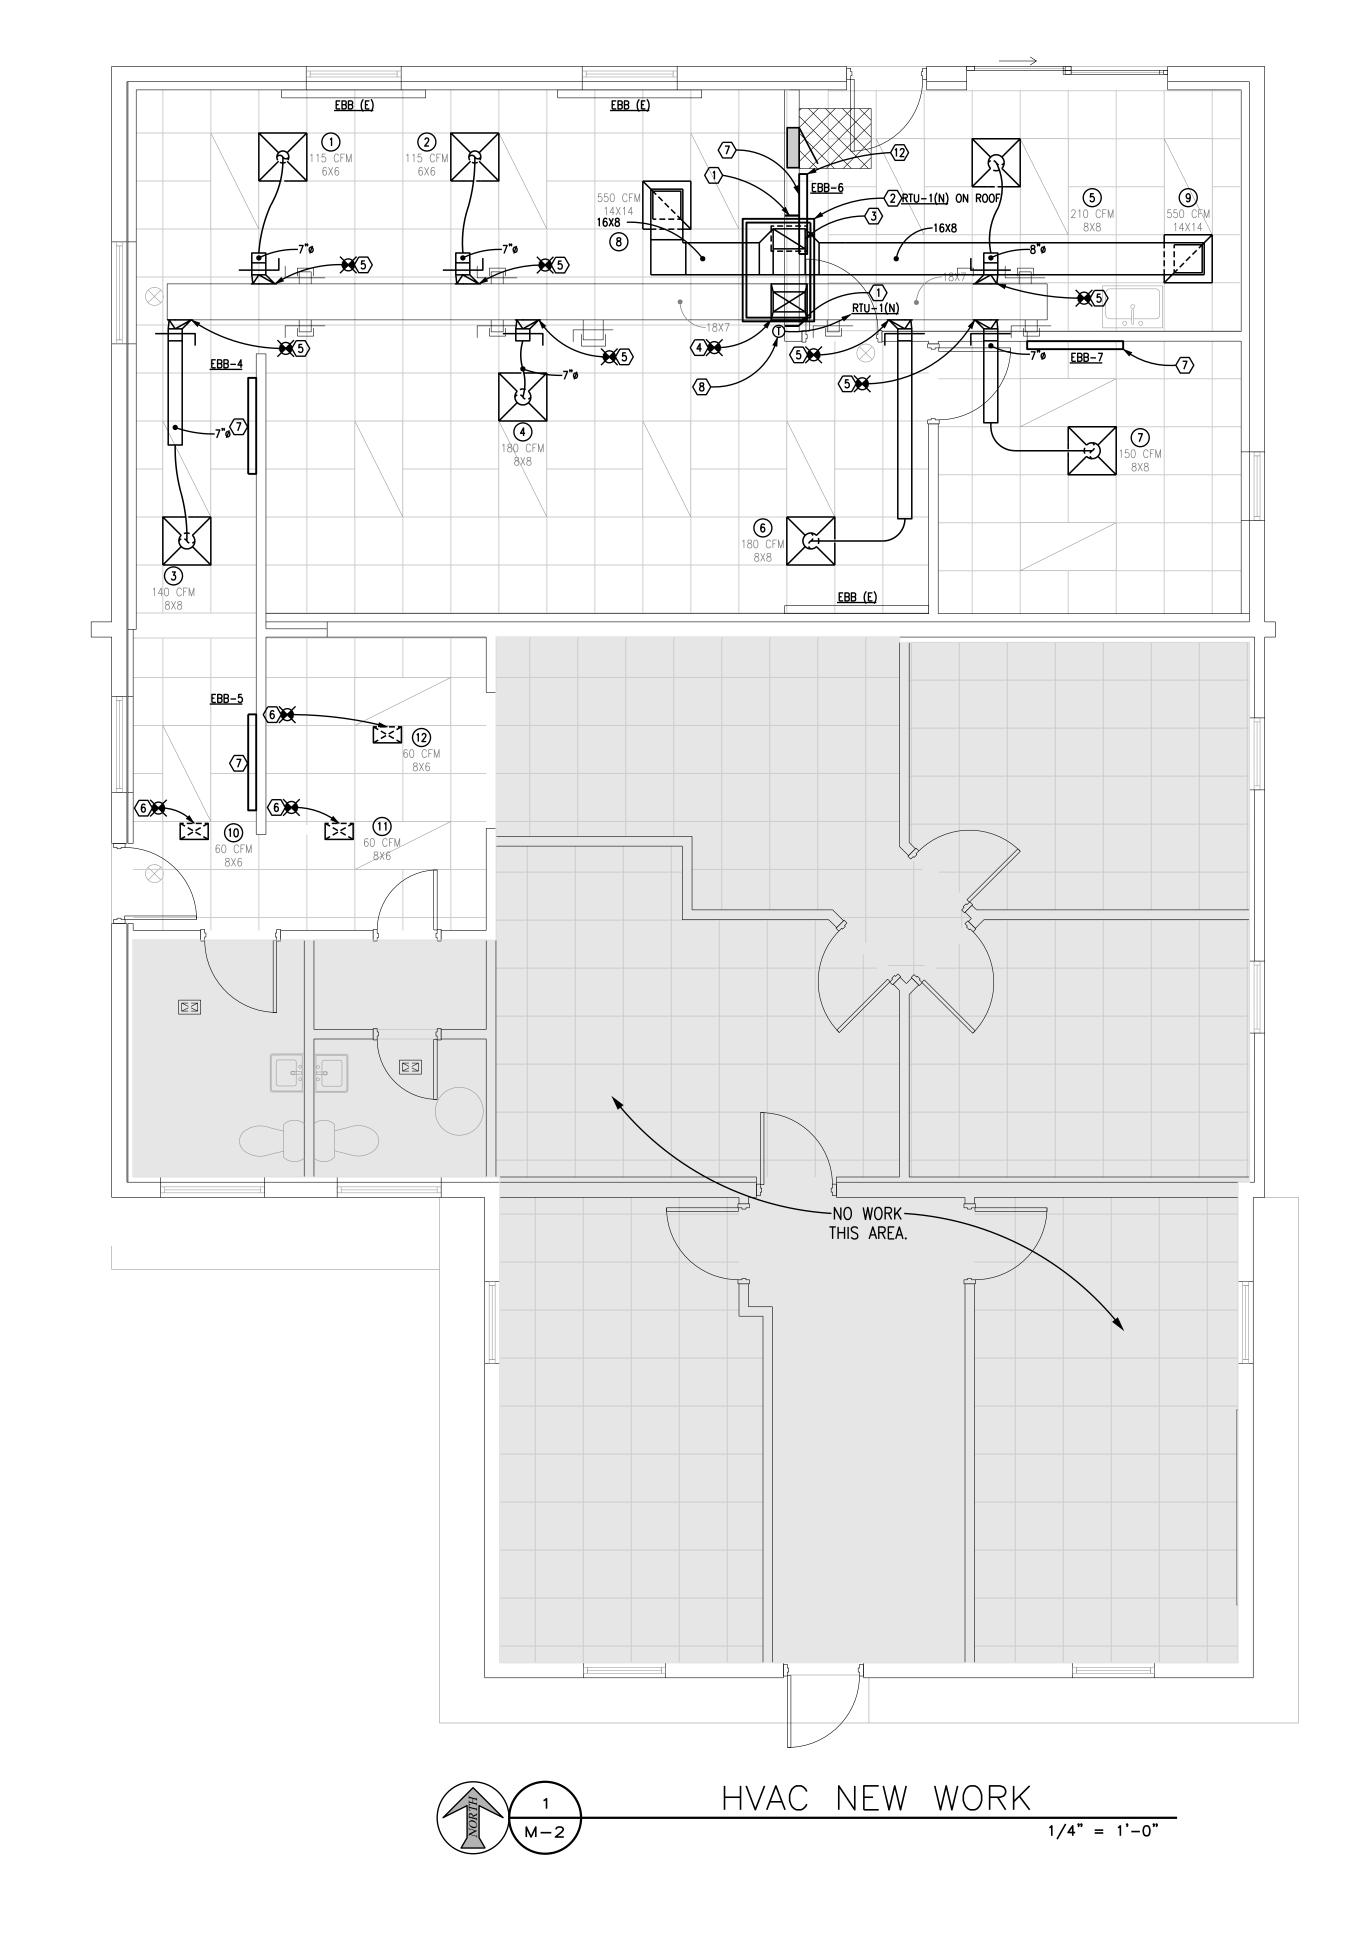

				GR	ILLE	and f	REGISTER	R BA	_ANC	E SCHE	<u>DULE</u>				
MARK	TYPE	SIZE	BAL. CFM	MARK	TYPE	SIZE	BAL. CFM	MAR	K TYP	E SIZE	BAL. CFM	MARK	TYPE	SIZE	BAL. CFM
1	S-1	6X6	115	4	S-1	8x8	180	7) s-	1 8x8	150	10	S-2	8x6	60
2	S-1	6X6	115	5	S-1	8x8	210	8) R-	1 14X14	550	11	S-2	8x6	60
3	S-1	8x8	140	6	S-1	8X8	180	9) R-	1 14X14	550	12	S-2	8x6	60



REVISIONS

23-153-01 DRAWN BY BJB 10.18.2021 **M-2**

COORDINATION NOTE

SWITCH, SPST

SWITCH, DIMMER

OUTLET, DUPLEX

OUTLET, SPECIAL PURPOSE

OCCUPANCY SENSOR


JUNCTION BOX

HORSE POWER

DEVICE TO REMAIN

VOICE/DATA OUTLET, BOX AND CONDUIT 3/4" CONDUIT TO ACCESSIBLE CLG. SPACE

IT IS ABSOLUTELY NECESSARY THAT ALL TRADES COORDINATE WITH EACH OTHER AND VERIFY THAT THERE ARE NO CONFLICTS IN LOCATION OF DUCTS, CONDUITS, SPRINKLER HEADS, DIFFUSERS, ELECTRICAL BOXES, EQUIPMENT, AND OTHER ITEMS THROUGHOU THIS PROJECT BEFORE FINAL PLACEMENT OF MATERIALS.

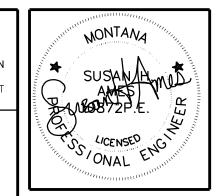



REVISIONS


T #23-153-01 REMODEL SPECIFICATIONS

PROJEC OFFICE

23-153-01 DRAWN BY SHA APPROVED SHA 10.18.2021

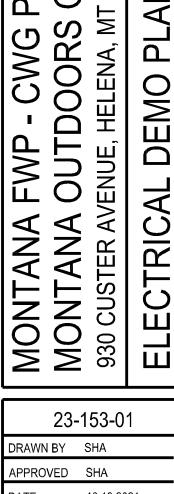

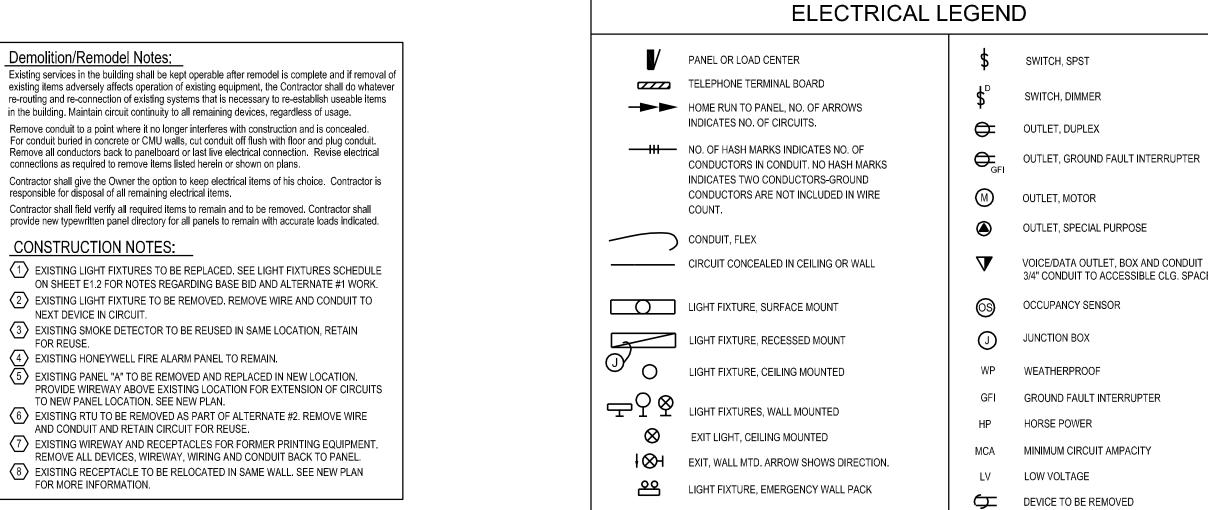

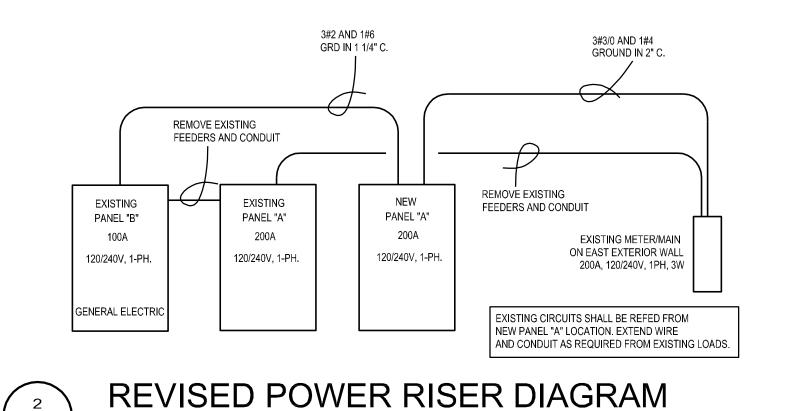

*CONTRACTOR SHALL REUSE AS MUCH EXISTING FEEDERS AS POSSIBLE TO SERVE THE NEW PANEL A AND EXISTING PANEL B.

Electrical Specifications

Scope: All electrical work under this contract as shown on the plans and indicated in the specifications. Work shall be performed by a licensed and bonded contractor utilizing tradesmen skilled in the art and in accordance with acceptable practices. All work shall comply with local, state, and the National Electrical Code, latest edition. Permits: The electrical contractor shall secure all permits in connection with his work. Work Included: All lighting and power systems including fixtures, devices, boxes, conduit, disconnects, motor starters, etc. Provide and install all incidental items required for a complete and functioning system. Service equipment, motors, etc. to be located and

installed as shown on the plan. Deviations shall be approved prior to installation by the architect and/or engineer. Tests: Prior to tests or usage, all switches, panels, devices shall be in place. All branch circuits shall be free of faults or shorts. The complete installation and all components shall have a resistance between conductors

and between conductors and ground as specified by the N.E.C. Ground: There shall be continuity of ground throughout the system. System ground to comply with N.E.C. requirements. Materials: All materials such as receptacles, switches, conduit, conductors,

panelboards, devices, fixtures, etc. to be new and bear the U.L. label or to conform to applicable standards.

Guarantee/Warranty: Contractor guarantees that all work and plant will be free from defects of materials and workmanship for a period of one (1) year from the date of final acceptance. Contractor further agrees that he will replace or repair all defective equipment and installation that become defective during the term of the warranty. This does not include excessive abuse or damage inflected by the owner and/or others.

Manufacturers Directions, Procedures and Operating Instructions: Manufacturers materials, and equipment applied, installed, connected, erected, used, cleaned, and conditioned as per manufacturers directions or recommendations prior to installation. Installation: All equipment, circuitry, etc. shall be installed as follows or as specified otherwise. The electrical contractor shall verify all nameplate ratings of equipment to be connected and verify electrical compatibility and code compliance. Manufacturer's recommendations shall take precedence unless verified otherwise.

Conductors and Cable: All conductors shall be copper with a weather resistant thermoplastic cover. No branch circuit conductors shall be smaller than #12 unless for low voltage wiring. Lighting Circuits: Lighting circuits shall not exceed 1920 watts and shall be for lighting only. No other equipment such as receptacles, small motors, computers, and other devices shall be connected to lighting circuits unless specifically shown on the plan or called out in the

Receptacle Circuits: There shall be no more than nine (9) receptacles on a 20A circuit. Additional loads such as small motors or equipment may be connected to receptacle circuits if indicated on the plan. Field verify for any deviations.

Motor Circuits: Motors and circuitry to be installed and connected as indicated on the plan All motors to be provided with a disconnecting means per the N.E.C. If fractional horsepower motors do not have an integral disconnecting means such as a plug or snap switch, electrical contractor to provide and install an acceptable disconnecting means. Equipment connected with flexible conduit with green jacketed ground wire within conduit-to-conduit system or equipment ground. Connect for correct rotation.

Conduits: PVC schedule 40 acceptable where routed underground. If PVC is used, provide ground wire. Compression couplings in wet locations and in concrete walls and floors. EMT required for interior runs.

Outlet Boxes:

Fixture and Special Purpose 4" x 4" x 2 1/8" Duplex, Switch and Telephone 3" x 2" x 2 3/4" Special Purpose Outlet 4" x 4" x 2 1/8"

NO SCALE

Wire and Cable: Type THHN or THWN for application or as noted otherwise. Type AF fixture wire where required including within lighting fixtures. Color code in accord


Current Characteristics: 120/240V, 1 phase, 3W

Wiring Devices: Product: Leviton, P&S, Hubbell, and Slater acceptable. Switch and receptacle colors; selected by owner. Devices and finish plates to match in color - no exceptions. 1. Standard switches 20 amps, 277 volt with matching smooth plastic plate. Mount 44"

a. 1 pole Single pole toggle, 20A, Model No. CSB1-20 2. Duplex outlet Nema standard WD 1 and 6, 20 amps, 125 volts grounded Model No. BR20 complete with smooth matching plate. Mount centerline at 18". 3. GFCI receptacle, 20 amp, 125 volt - Model number 6899I with matching plate zinc weather


resistant cover where indicated W.P. Equipment Connections: Electrical contractor to coordinate all work where he is responsible for connecting equipment supplied by others. Verify equipment plug configurations and


direct connect or install receptacle to match plug. Verify box mounting heights prior to rough in. Disconnect and Schedule of Control Equipment: Product of General Electric, Square D, Cutler Hammer, and Westinghouse acceptable. Model, style, etc. as scheduled. Install fuses for disconnects if required and heaters for motor controllers as recommended by motor equipment supplier. Coordinate controls wiring as indicated on the schedule and make allowances there of.

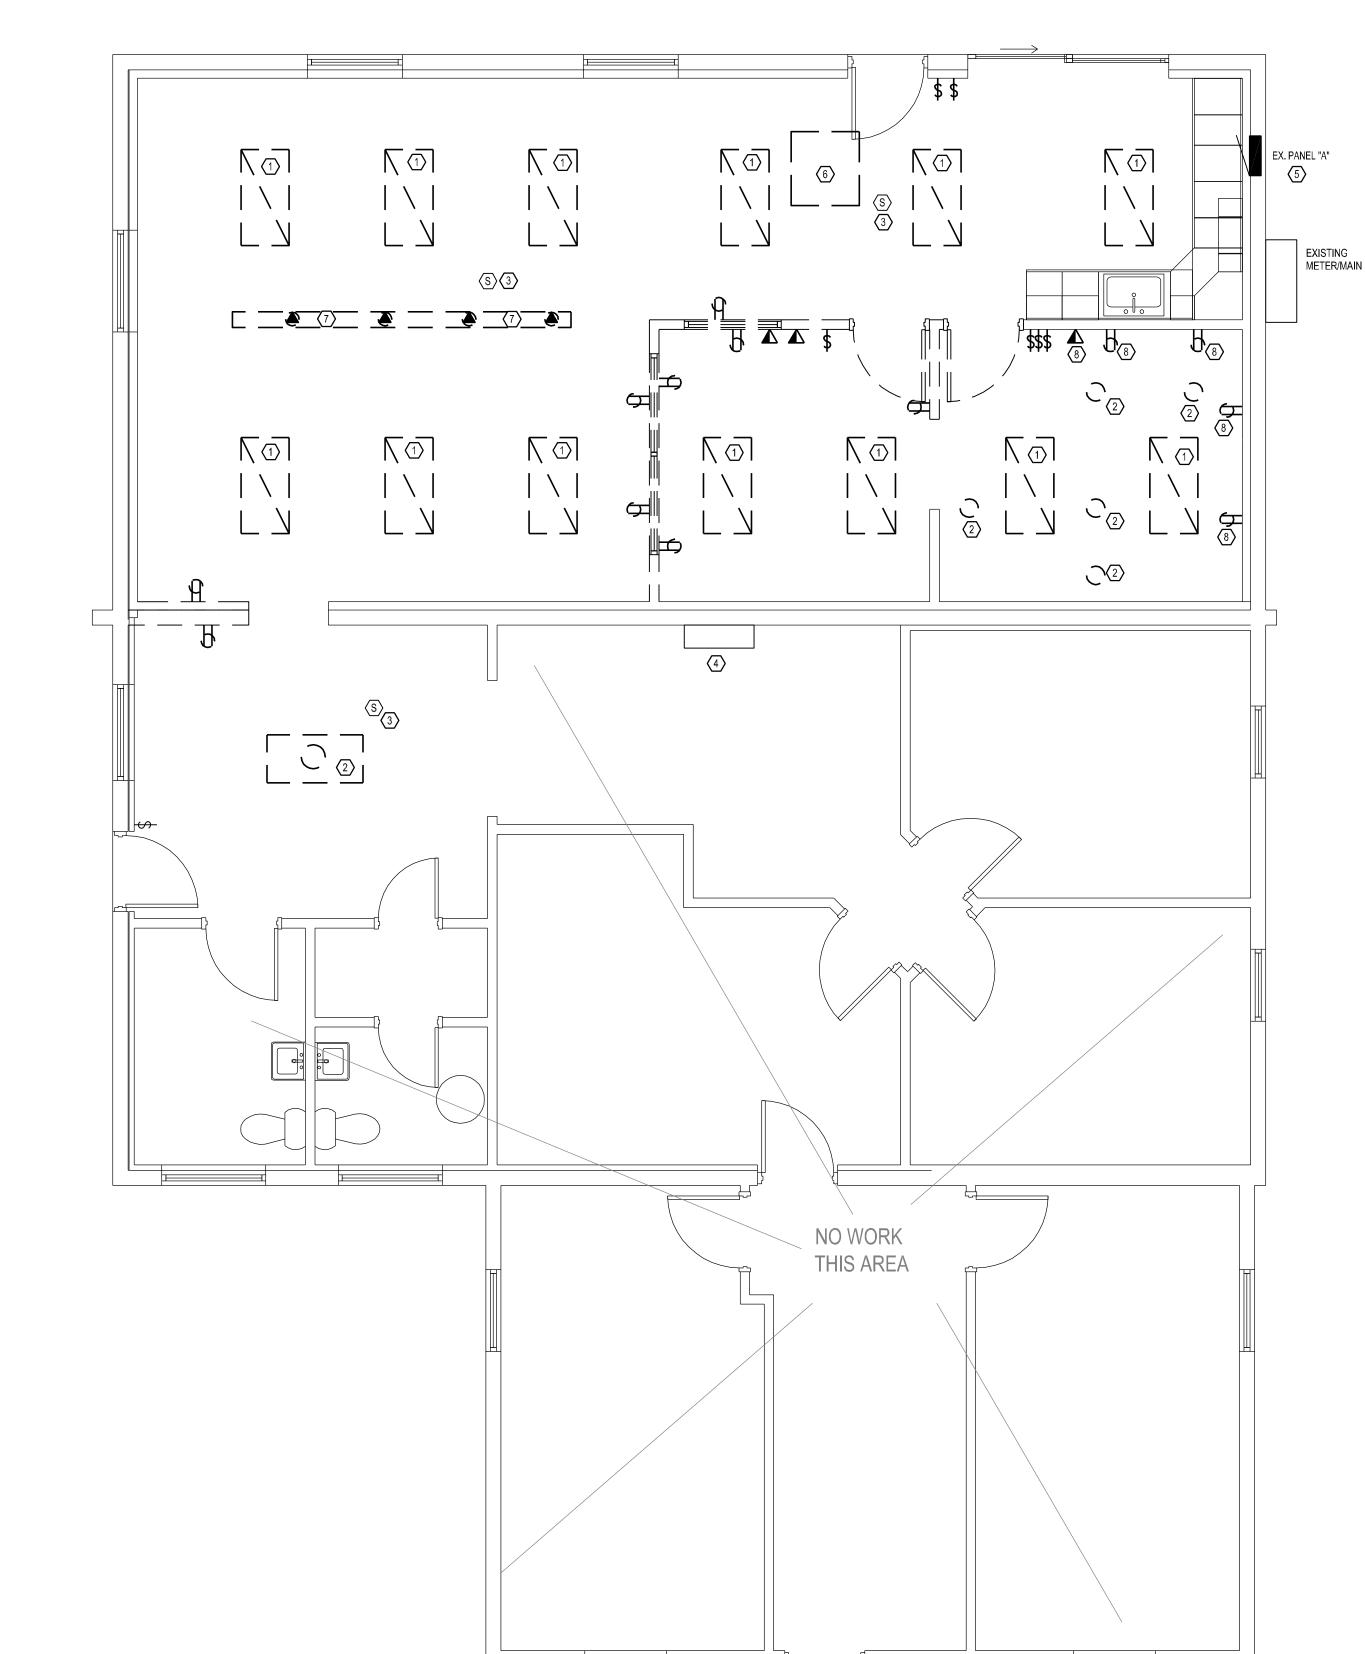

ELECTRICAL DEMOLITION PLAN

1/4"=1'-0"

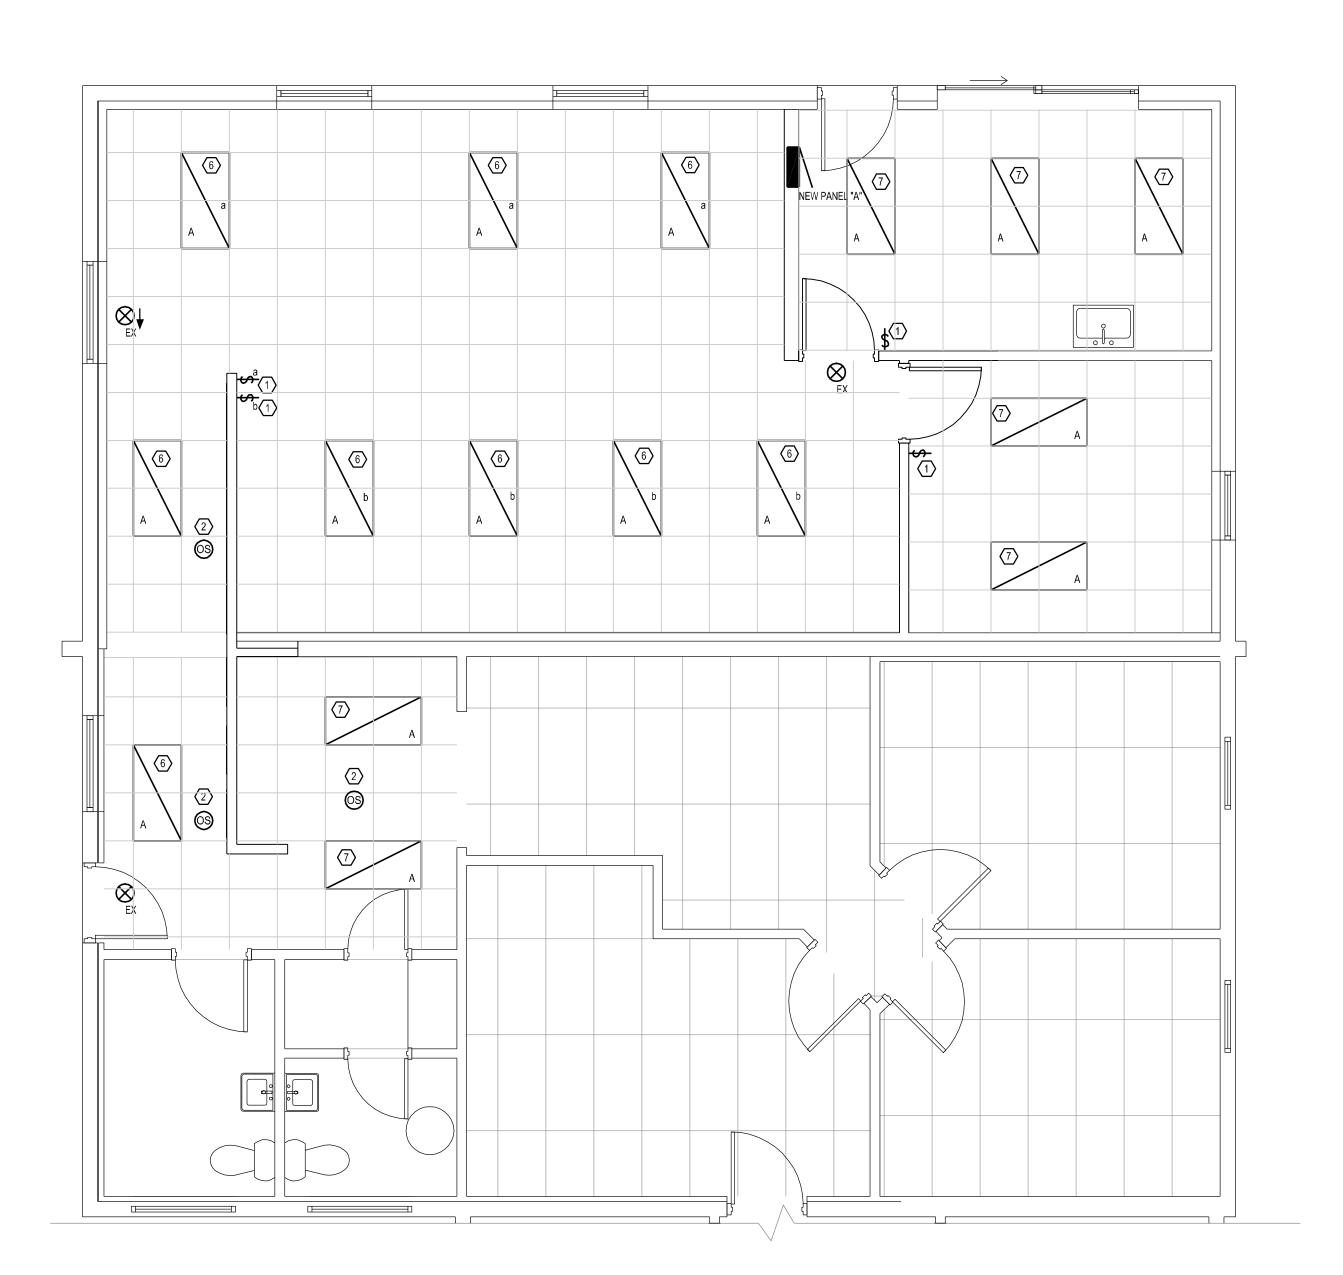

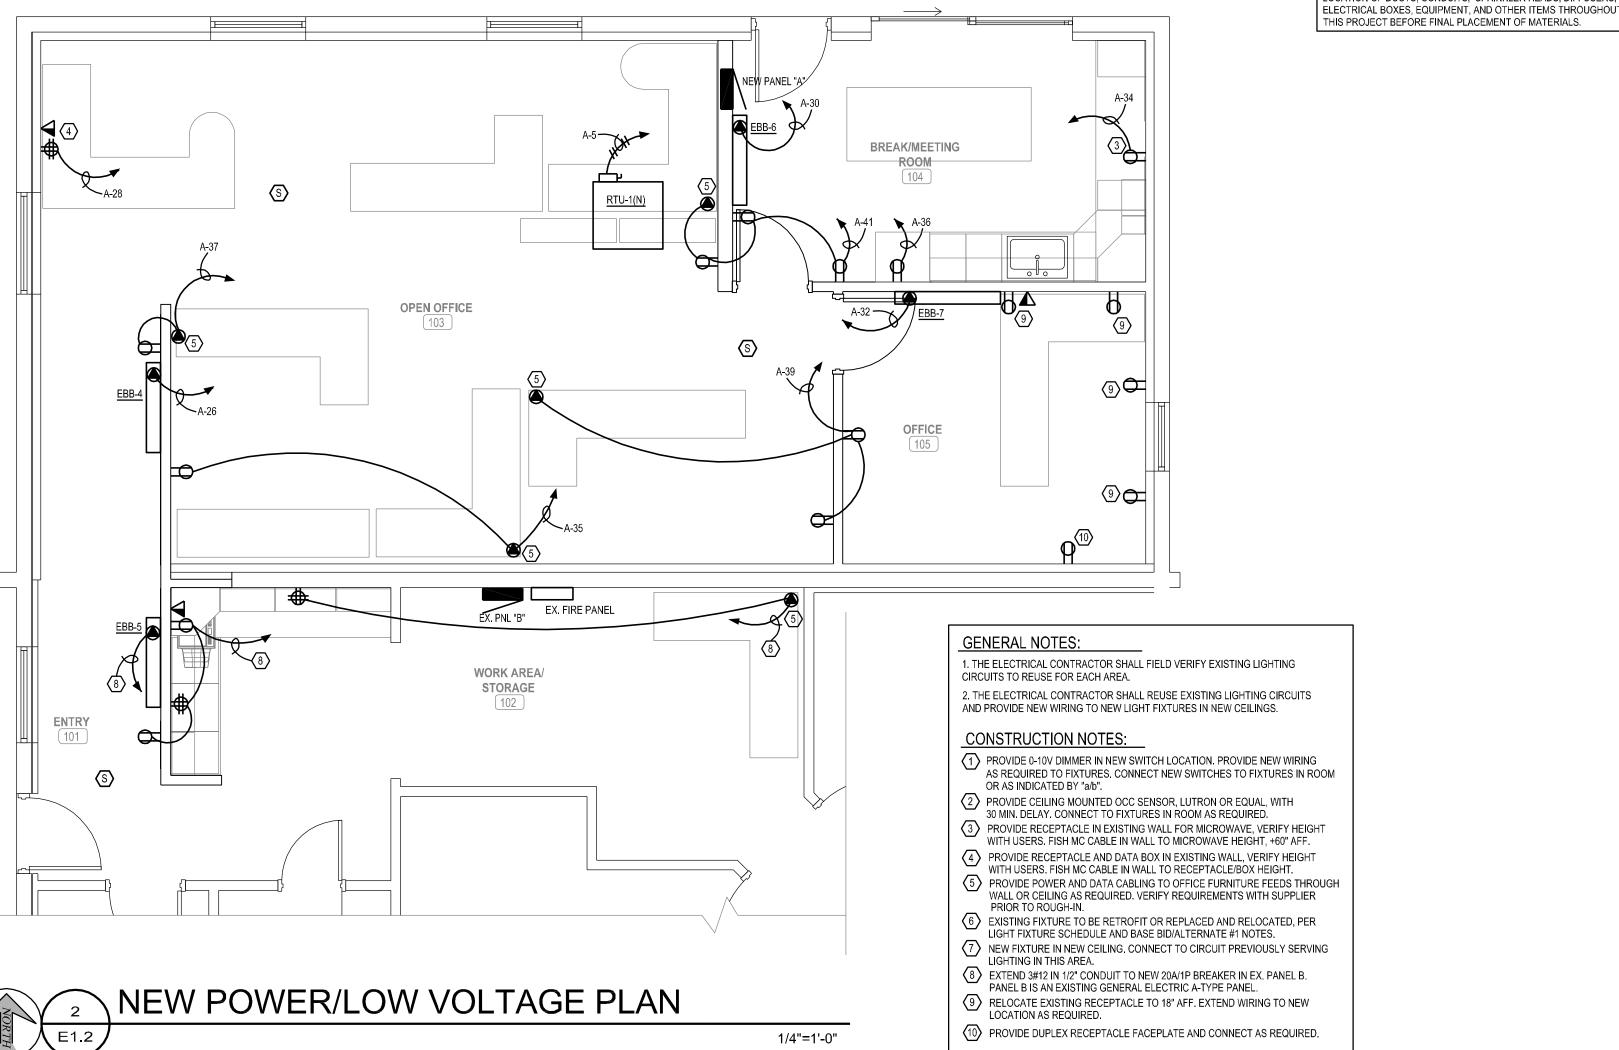

NEW LIGHTING PLAN

		LI	GHT FIXTU	JRE SCHEDI	JLE				
LTR.	SYMBOL	DESCRIPTION	MANUFACTURER	CATALOG NO.	LOCATION	MOUNTING	NO.	LAMPS_ WATTAGE	NOTES
A BASE		2'X4' RECESSED VOLUMETRIC RETROFIT KIT LED DIMMABLE LAMPING	ELKO	VOL24R-PS34-840-UD DIMMABLE	CEILING	RECESSED	1	34W LED	120V
A ALT #1		2'X4' RECESSED FLAT PANEL LED DIMMABLE LAMPING	LITHONIA	CPANL-2X4-40LM-40K DIMMABLE	CEILING	RECESSED	1	32W LED	120V
EX	\otimes	SINGLE FACE RED LED BRUSHED ALUM. STENCILED EXIT NICKEL CAD. BATTERY	LITHONIA	LQC-1R-120-ELN	CLG.	SURFACE	-	RED LED'S	1 120V.

NOTES:

1 CONNECT EMERGENCY AND EXIT FIXTURES TO NEAREST UNSWITCHED 120V. CIRCUIT.

BASE BID: PROVIDE RETROFIT KIT IN NINE EXISTING 2X4 TROFFERS. FIELD VERIFY KITS WILL FIT INTO EXISTING FIXTURES PRIOR TO ORDERING. ALTERNATE #1: PROVIDE NEW FIXTURES TO REPLACE NINE EXISTING LIGHTS.

					MOTO	R SC	HED	ULE					
		*\	/ERIF	Y EXACT LO	CATIONS OF	ALL	EQUIF	PMEN	T PRIO	R TO R	OUGH-IN		
UNIT MANUFACTURER STARTER O.L. DEVICES AUXILIARY CONTROL NOTE:													
UNIT	HP	PH	VOLTS	MFR	CATALOG NO. SIZE		POLES	HTRS	SWITCH PILOT		EQUIP. & DEVICES	INOTES	
EBB-4,5,7	1kW	1	120		N/A							1	
EBB-6	750W	1	120		N/A							1	
RTU-1(N)	18.8 MCA	1	240		N/A							12	
<u> </u>	•	•											

SEE TEMPERATURE CONTROL SPECIFICATIONS IN MECHANICAL SPECS FOR SEQUENCE OF OPERATION, INTERLOCKS, AND SPECIAL CONTROLS REQUIRED; ALSO FOR DEFINITION OF WHICH CONTRACTOR PROVIDES WHAT.

1/4"=1'-0"

PROVIDE NEMA 3R, 30A/2P FUSED DISCONNECT SWITCH ADJACENT TO UNIT. PROVIDE FUSES PER MANUFACTURER'S RECOMMENDATIONS. ALL WORK RELATED TO THE REPLACEMENT OF THE RTU SHALL BE PART OF ALTERNATE #2.

V V	<u> </u>		AGL				OCATION AS	REQUIRED.		2 10 10 71	1.2//2/10	WIRING TO NEW									
					1/	/4"=1'-()"			(10) P	ROVIDE DUP	LEX RECEP	TACLE F	ACEPLATE .	AND CONNE	ECT AS REQUIRED.					
PANEL	1		AMPS				BUS				FLUSH					EXTEND FEEDERS TO NEW PANEL LOCATION					
		M 104	L-L V	240			NEUT]		FEE		TOP										
MFGR. TYPE			L-N V PHASE				.C.B. YPE	NO	WIE DEF		20" 5 3/4"						FROM	EXISTIN	IG LOA	DS	
	10K		WIRES			E		YES	NEN		1										
	-																				
REMAF	RKS:	*ALL CI	RCUIT BRE	ERS ONLY, HACR BREAK TAKERS SHALL BE RATE TH THE CURRENT LIMITIN	D 10,000	O AIC A	ND LI	STED F	FOR S	SERIES		CTURE	R								
CKT	BRI	EAKER	17(1101(11)		T T		USE	Oii (OO		LOAD(US	SE .				BREA	KER	CKT	
NO.		POLE	T WIRE	LOAD DESCRIPTION	REC	1		MTR	MISC	,	L2	REC L			MISC	LOAD DESCRIPTION	WIRE	and the same of th	POLE	T NO.	
1	100	2	#2	EX PANEL B					1	6000											
										500			1			EXISTING BB HEAT	#12	20	2		
3									1		6000		١,								
	30	2	#10	RTU-1(N)			1			1800	500		1								
3	30		#10	1X10-1(IV)			'			500			1			EXISTING BB HEAT	#12	20	2		
7							1				1800						., , _		_		
											500		1								
9	20	1	#12	EXISTING LOAD					1	500											
			2.15	EVANTULE : 2 · 2						500	500		1			EXISTING BB HEAT	#12	20	2		
11	20	1	#12	EXISTING LOAD					1		500										
13	20	1	#12	EXISTING LOAD					1	500	500		1								
13	20		#12	LAISTING LUAD						500			1			EXISTING BB HEAT	#12	20	2		
15	20	1	#12	EXISTING LOAD					1	300	500					ENGTING DBTIERT	#12	20			
, ,											500		1								
17	20	1	#12	EXISTING LOAD					1	500											
										500			1			EXISTING BB HEAT	#12	20	2		
19	20	1	#12	EXISTING LOAD					1		500										
	20		1140	EVICTING LOAD						500	500		1								
21	20	1	#12	EXISTING LOAD					1	500 500			4			EVICTING DD LIEAT	#12	20	2		
23	20	1	#12	EXISTING LOAD					1	500	500		1			EXISTING BB HEAT	#12	20	2		
23	20	'	#12	LAGTING LOAD							500		1								
25	20	1	#12	EXISTING LOAD					1	500											
										1000			1			EBB-4	#12	20	1	2	
27	20	1	#12	EXISTING LOAD					1		500										
											1000	1				RECEPTACLES	#12	20	1	2	
29	20	1	#12	EXISTING LOAD					1	500						EDD 6	412	20	1		
31	20	1	#12	EXISTING LOAD					1	750	500		1			EBB-6	#12	20	1	;	
31	20	1	#12	LAGTING LOAD							1000		1			EBB-7	#12	20	1	;	
33	20	1	#12	EXISTING LOAD					1	500	1555										
										1000		1				RECEPTACLES	#12	20	1	;	
35	20	1	#12	RECEPTACLES	1						1000										
			1140	DECEDTA CLEO						4000	1000	1				RECEPTACLES	#12	20	1		
37	20	1	#12	RECEPTACLES	1					1000						SPARE		20	1		
39	20	1	#12	RECEPTACLES	1						1000					SFARE		20	1	,	
38	20	1	π12	NEOLI INOLLO	'						1,000					PROVISION					
41	20	1	#12	RECEPTACLES	1					1000											
																PROVISION					
										19050	18800										
														ECTED			DIV.	DEM			
TO	IAL C	ONNEC	TED LOAD							37850	VA			OKVA	7.0	KVA	100%		KVA		
												REC	REM/ LIGH	AINING		KVA KVA	50% 125%		KVA KVA		
BREAK	EB T	YPES								I () 4 () /	PHASE			HEAT	11.4		125%		KVA		
N = N		11 LJ								50%				TORS	11.4	KVA	100%		KVA		
EX = I		ING								50%		MISC		NEOUS	18.5		100%		KVA		
G = G											<u> </u>				D LOAD	3			KVA		
		·								,,,,,,,,,,,,,,,,,,,,,,,,,,,,,,,,,,,,,,,					O AMPS				AMPS		
						-					_		_	_	_				_		

MONTANA FWP - CWG PROJECT #23-153-01 FWP PROJECT #7
MONTANA OUTDOORS OFFICE REMODEL
930 CUSTER AVENUE, HELENA, MT 59602

COORDINATION NOTE

IT IS ABSOLUTELY NECESSARY THAT ALL TRADES COORDINATE WITH EACH OTHER AND VERIFY THAT THERE ARE NO CONFLICTS IN LOCATION OF DUCTS, CONDUITS, SPRINKLER HEADS, DIFFUSERS,

MONTANA

SYONAL T

REVISIONS

JEDULES

POWER/LOW VOLTAGE PLANS

23-153-01

DRAWN BY SHA

APPROVED SHA

DATE 10.18.2021