

Addendum

Addendum No. 1

Date: 11/4/2021 **Project Number:** 23-153-01

Project: Montana Fish, Wildlife, & Parks

Montana Outdoor Office Remodel

930 Custer Avenue, Helena, Mt 59602

Bid Date: 11/18/2021

3:00 p.m. M.D.T.

Montana Fish Wildlife & Parks

1522 9th, Ave, MT 59620

Bidders for the above-captioned project are hereby informed that the drawings and/or specifications are modified, corrected, or supplemented as follows. Acknowledge receipt of Addenda on Bid Form.

General Notes:

ITEM G-1	All re-issued drawings sheets will be indicated with an 'R' at the end of
	the cheet # /Cycomple Ad AD)

the sheet # (Example A1.1R).

ITEM G-2 See electrical demo note #3 for smoke detectors to be re-used in the

same locations.

ITEM G-3 A full time superintendent will not be required for this project. However, should

be available during normal working hours.

ITEM G-4 Contractor is responsible for paying for building permit. Should include this in

bid price.

ITEM G-5 Contractor is allowed to use power and water onsite.

ITEM G-6 Access to site is through south gate along Custer Ave., Owner to coordinate

with contractor in receive gate access code. For access before and after

normal business hours and weekends.

ITEM G-7 FWP will coordinate staging area with contractor on-site.

ITEM G-8 Contractor is responsible for remove of debris from project site.

ITEM G-9 Existing and New door frames and window trim to be painted as called out on

room finish schedule or unless otherwise noted.

ITEM G-10 MECHANICAL SPECIFICATION NOTE: All work shall be in strict compliance

with all applicable codes & standards, including but not limited to, 2018 IMC,

2018 UPC, 2018 IBC, 2018 IFGC & 2018 IECC. Contractor shall be

responsible for obtaining permits, plan reviews, and all required inspections by the code authorities having jurisdiction. See attached mechanical addendum.

ITEM G-11 MECHANICAL SPECIFICATION NOTE: Testing and balancing of all ducts

and grills modified/replaced in this project is required. Testing and balancing is to be done by a NEBB certified balancing agency. See attached mechanical

addendum.

CWG Architecture

Architecture Engineering Design

(406) 443-2340

650 Power St P.O. Box 1198 Helena, MT 59624

cwg-architects.com

Amendments to the Project Manual:

N/A

Amendments to the Drawings:

- ITEM A-1 SHEET AD1.0R DEMO FLOOR PLAN: (2) additional base cabinets to be relocated by contractor. Coordinate location with owner. See re-issued architectural sheet AD1.0R
- ITEM A-2 SHEET AD1.0R DEMO FLOOR PLAN: (1) additional upper cabinet to be removed completely on north wall of open office area. See re-issued architectural sheet AD1.0R
- ITEM A-3 SHEET AD1.0R DEMO FLOOR PLAN: Add demo plan note #D15 for extend of LVT removal in existing breakroom. See re-issued architectural sheet AD1.0R
- ITEM A-4 SHEET A1.1R FIRST FLOOR PLAN: Window legend references window type W1. Window tag has been added for reference. See re-issued architectural sheet A1.0R
- **SHEET A1.1R FIRST FLOOR PLAN: Wall Legend:** Wall type MS has been updated to reference wall types MS3 & MS6. See re-issued architectural sheet A1.0R
- ITEM A-6 SHEET A1.1R FIRST FLOOR PLAN: Detail #5 clarification: Delete reference detail to 1/S1 and replace with 2/S1. See re-issued architectural sheet A1.0R
- ITEM A-7 SHEET A1.1R FIRST FLOOR PLAN: Room Finish Schedule: Office 105 & Office 106 will not receive new ceilings. See re-issued architectural sheet A1.0R
- SHEET A1.1R FIRST FLOOR PLAN: Room Finish Schedule: Work Area/ Storage 102 to receive new rubber base. See re-issued architectural sheet A1.0R
- SHEET A1.1R FIRST FLOOR PLAN: Room Finish Schedule: Delete note at Entry 101 that references wall to receive level 1 texture on this side of wall. Replace with plan note #4. See re-issued architectural sheet A1.0R
- ITEM A-10 SHEET A2.1R RELECTED CEILING PLAN Detail #5 clarification: Delete reference detail to 2/S1 and replace with 1/S1. See re-issued architectural sheet A2.1R
- ITEM A-11 SHEET A2.1R REFLECTED CEILING PLAN: Detail #3 clarification: Per City review comment provide positive drainage around roof equipment. See reissued architectural sheet A2.1R
- ITEM M-1 SHEET M-2 HVAC NEW WORK: Electrical Baseboard Heater: Note 1 to read as follows: "Complete with integral thermostat, disconnect means, high limit protection, factory white finish. See attached mechanical addendum.

ITEM E-1 SHEET E1.2R LIGHTING AND POWER\LOW VOLTAGE PLANS, AND

SCHDULES: Occupancy sensors will be required in the following rooms: Entry 101, Open Office 103, Breakroom 104, Office 105, See re-issued electrical sheet E1.2R.

ITEM E-2 SHEET E1.2R LIGHTING AND POWER\LOW VOLTAGE PLANS, AND

SCHDULES: Add emergency lighting fixtures. See re-issued electrical

sheet E1.2R.

ITEM E-3 SHEET E1.2R LIGHTING AND POWER\LOW VOLTAGE PLANS, AND

SCHDULES: Delete construction note #5 and replace with the follow: "Provide power feeds to office furniture through wall or ceiling as required. Verify requirements with supplier". See re-issued electrical sheet E1.2R.

ITEM E-3 SHEET E1.2R LIGHTING AND POWER\LOW VOLTAGE PLANS, AND

SCHDULES: Add general note #3: "Add general note as follows: All data cabling, jacks and final connections will be supplied and installed by the owner. See re-issued electrical sheet E1.2R.

Prior Approvals:

LIGHT FIXTURE:

The following light fixtures have been reviewed as equals, subject to final approval, to specified light fixtures:

Fixture "A (base)" Litetronics Fixture "A (alternate)" Litetronics Fixture "EX" Mule Lighting

See attached Electrical addendum.

ROOFTOP UNIT:

McQuay, Carrier, Trane, and Johnson Controls are approved to bid the Rooftop Unit. It is the responsibility of the G.C. to coordinate any deviations from the plans with all other trades at no additional cost to the owner if a unit other than the one scheduled on the plans is used. See attached mechanical addendum.

END OF ADDENDUM


Crossman-Whitney-Griffin, P.C.

Matthew Avard, Project Manager

Attachments:

- Sheet AD1.0R Demo Plan
- Sheet A1.1R First Floor Plan New
- Sheet A2.1R Reflected Ceiling plan
- Sheet E1.2R
- Mechanical Addendum
- Electrical Addendum

PLEASE ACKNOWLEDGE RECEIPT OF THIS ADDENDUM ON THE DESIGNATED PLACE IN THE PROPOSAL FORM AND ON THE FACE OF THE ENVELOPE.

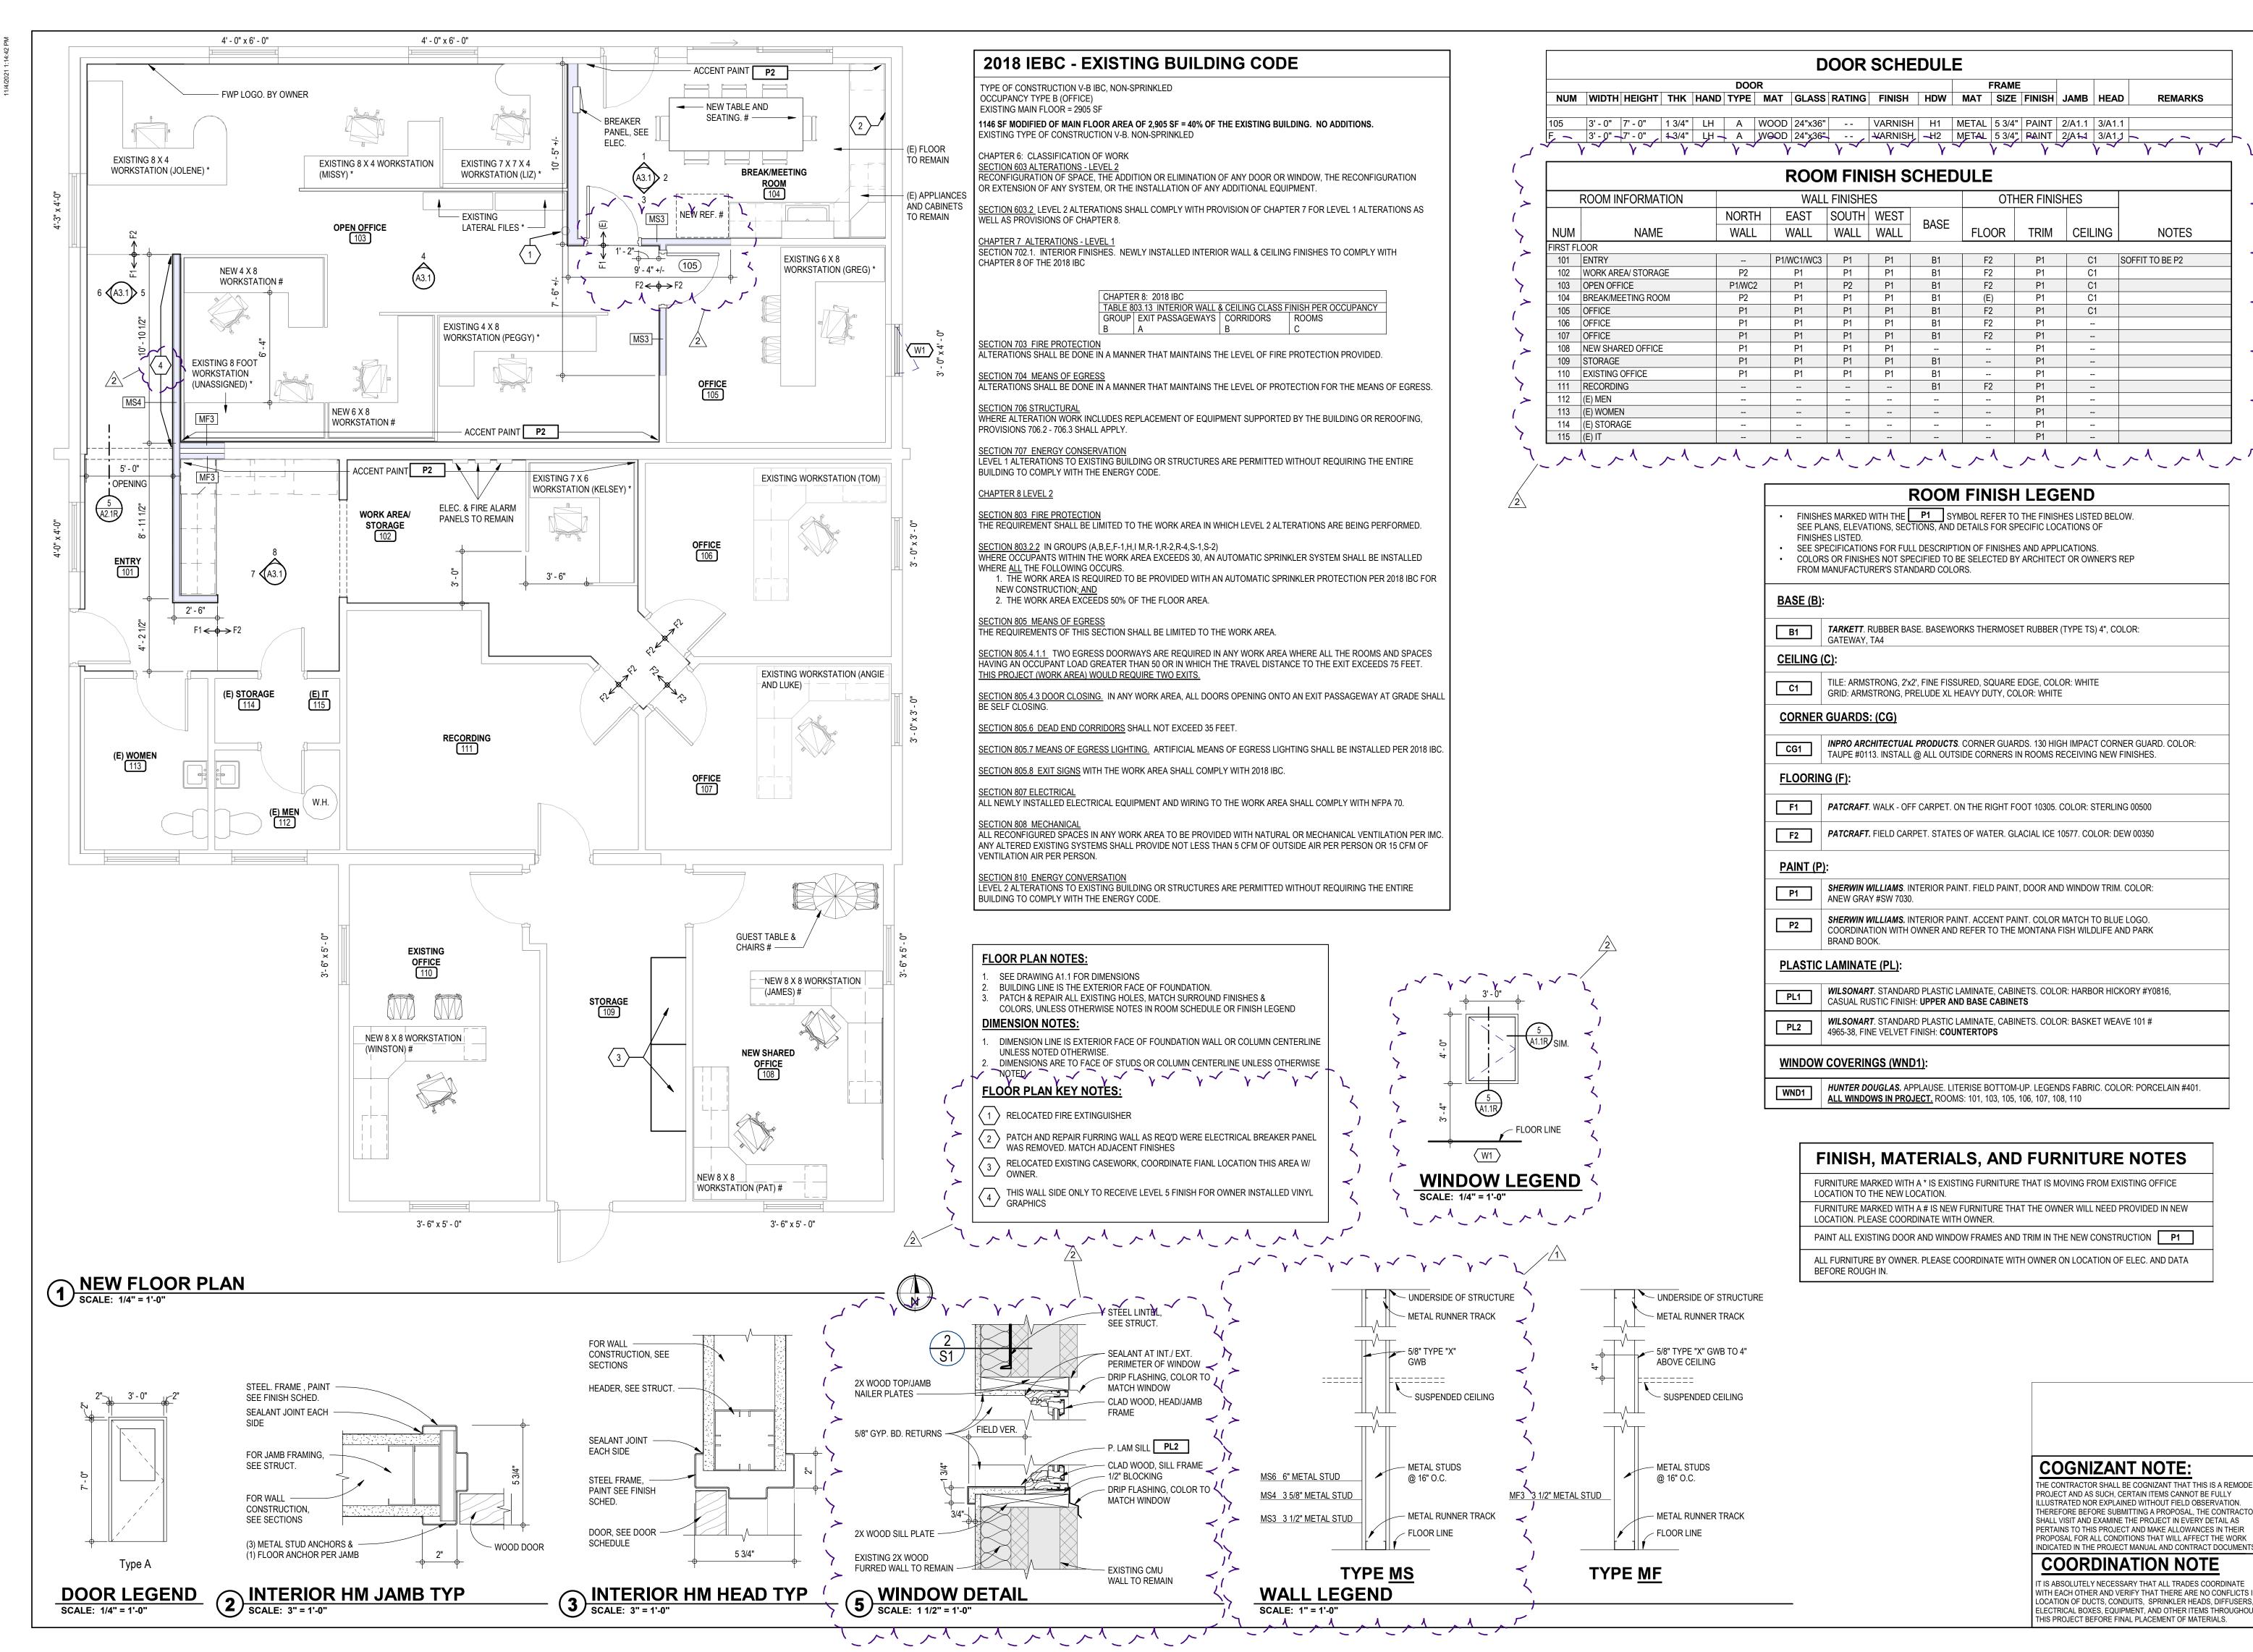

REVISIONS

11/2/21

PARKS SE REMODE <u>~ C</u> 1, WILDLIFE, & TDOORS OFFICHERNA, MT 59602

23-153-01 APPROVED CWG

DRAWN BY MMA/MM **DATE** 11.04.21

REVISIONS

DATE

11/2/21

A FISH, WILDLIFE, & PARKS
A OUTDOORS OFFICE REMOD
AVENUE, HELENA, MT 59602 MONTANA I MONTANA (930 CUSTER AVE

CEILING

TED

23-153-01 DRAWN BY MMA APPROVED CWG

DATE 11.04.21

COORDINATION NOTE

IT IS ABSOLUTELY NECESSARY THAT ALL TRADES COORDINATE WITH EACH OTHER AND VERIFY THAT THERE ARE NO CONFLICTS IN LOCATION OF DUCTS, CONDUITS, SPRINKLER HEADS, DIFFUSERS, ELECTRICAL BOXES, EQUIPMENT, AND OTHER ITEMS THROUGHOUT THIS PROJECT BEFORE FINAL PLACEMENT OF MATERIALS.

GENERAL DEMO PLAN NOTES COORDINATE ALL WORK IN (E) BUILDING WITH OWNER, PORTIONS OF THE BUILDING WILL REMAIN OCCUPIED DURING CONSTRUCTION, CONTRACTOR TO COORDINATE W/ OWNER FOR SEQUENCING OF DEMOLITION TO MINIMIZE IMPACT TO BUSINESS OPERATIONS. 2. CONTRACTOR TO COORDINATE WITH OWNER BEFORE START OF DEMO FOR OWNER TO REMOVE FURNITURE, EQUIPMENT AND OWNER SALAVAGED ITEMS. SEE MECHANICAL, ELECTRICAL DRAWINGS FOR ADDITIONAL DEMO NOTES PROTECT EXISTING CONSTRUCTION TO REMAIN, REPAIR ANY DAMAGE TO MATCH EXISTING ADJACENT CONSTRUCTION OR REPLACE ITEMS AS REQUIRED. CONTRACTOR TO FIELD VERIFY EXISTING CONDITIONS PRIOR TO BEGINNING DEMOLITION. NOTIFY ARCHITECT/OWNER OF ANY ITEMS THAT WOULD INTERFERE WITH PROCEEDING WITH DEMOLITION AS INDICATED OR DEVIATES FROM ASSUMED CONDITIONS. CONTRACTOR TO COMPLY WITH ALL EPA, FEDERAL, STATE AND LOCAL REGULATIONS FOR DISPOSAL OF CONSTRUCTION MATERIALS. REMOVAL AND DISPOSAL OF ALL DEMOLISHED ITEMS WITHIN THE LIMIT OF WORK AREA UNLESS OTHERWISE NOTED. CONTRACTOR TO PROVIDE ALL TEMPORARY PARTITIONS AND OTHER SYSTEMS TO CONTROL THE SPREAD OF CONSTRUCTION DEBRIS & DUST. CONTRACTOR TO PROVIDE ALL TEMPORARY SHORING AND BRACING, SEE 8. PATCH AND REPAIR ANY FINISHES TO MATCH ADJACENT FINISHES. **DEMO KEY NOTES:** D1 SAWCUT EXTERIOR/INTERIOR CMU BLOCK WALL FOR NEW OPENING, SEE WINDOW & DOOR LEGEND D2 REMOVE EXISTING INTERIOR FRAMED WALL COMPLETELY D3 REMOVE EXISTING EXTERIOR/INTERIOR DOOR/ DOOR FRAME & DOOR HARDWARE COMPLETELY ⟨D4⟩ REMOVE EXISTING INTERIOR WINDOW COMPLETELY \langle D5 \rangle REMOVE EXISTING RUBBER BASE COMPLETELY, PREP WALL SURFACE FOR NEW RUBBER BASE REMOVE EXISTING BROADLOOM CARPET OR LVT FLOORING COMPLETELY, PREP FLOOR SURFACE D6 FOR NEW FLOOR FINISHES REMOVE EXISTING WALL CASEWORK AND SELVING COMPLETELY, PATCH AND REPAIR WALL FOR **NEW FINISHES** (D8) REMOVE EXISTING CEILING TILES & GRID COMPLETELY REMOVE EXISTING 12" X 12" FULLY ADHERED CEILING SYSTEM AND FRAMING SYSTEM COMPLETELY, D9 PREP FOR NEW LAY-IN CEILING SYSTEM D10 REMOVE EXISTING ELECTRICAL BREAKER PANEL. SEE ELEC. D11 REMOVE & RELOCATE EXISTING FIRE EXTINGUISHER (D12) REMOVE & RELOCATE EXISTING BASE CABINETS W/ COUNTERTOPS D13 REMOVE EXISTING BASE & UPPER CASEWORK AND/OR WALL SHELVING COMPLETELY.

D14 REMOVE EXISTING GYP. BD. TO 5' - 0"A.F.F. SELECTIVE REMOVAL OF EXISTING LVT FLOORING OUTSIDE OF BREAKROOM 104. SEE NEW FLOOR PLAN ON A1.1 FOR EXTENT OF LVT TO REMAIN. PROTECT LVT FLOORING

COGNIZANT NOTE: THE CONTRACTOR SHALL BE COGNIZANT THAT THIS IS A REMODEL PROJECT AND AS SUCH, CERTAIN ITEMS CANNOT BE FULLY ILLUSTRATED NOR EXPLAINED WITHOUT FIELD OBSERVATION. THEREFORE BEFORE SUBMITTING A PROPOSAL, THE CONTRACTOR SHALL VISIT AND EXAMINE THE PROJECT IN EVERY DETAIL AS PERTAINS TO THIS PROJECT AND MAKE ALLOWANCES IN THEIR PROPOSAL FOR ALL CONDITIONS THAT WILL AFFECT THE WORK INDICATED IN THE PROJECT MANUAL AND CONTRACT DOCUMENT

COORDINATION NOTE IT IS ABSOLUTELY NECESSARY THAT ALL TRADES COORDINATE WITH EACH OTHER AND VERIFY THAT THERE ARE NO CONFLICTS IN LOCATION OF DUCTS, CONDUITS, SPRINKLER HEADS, DIFFUSERS, ELECTRICAL BOXES, EQUIPMENT, AND OTHER ITEMS THROUGHOUT THIS PROJECT BEFORE FINAL PLACEMENT OF MATERIALS.

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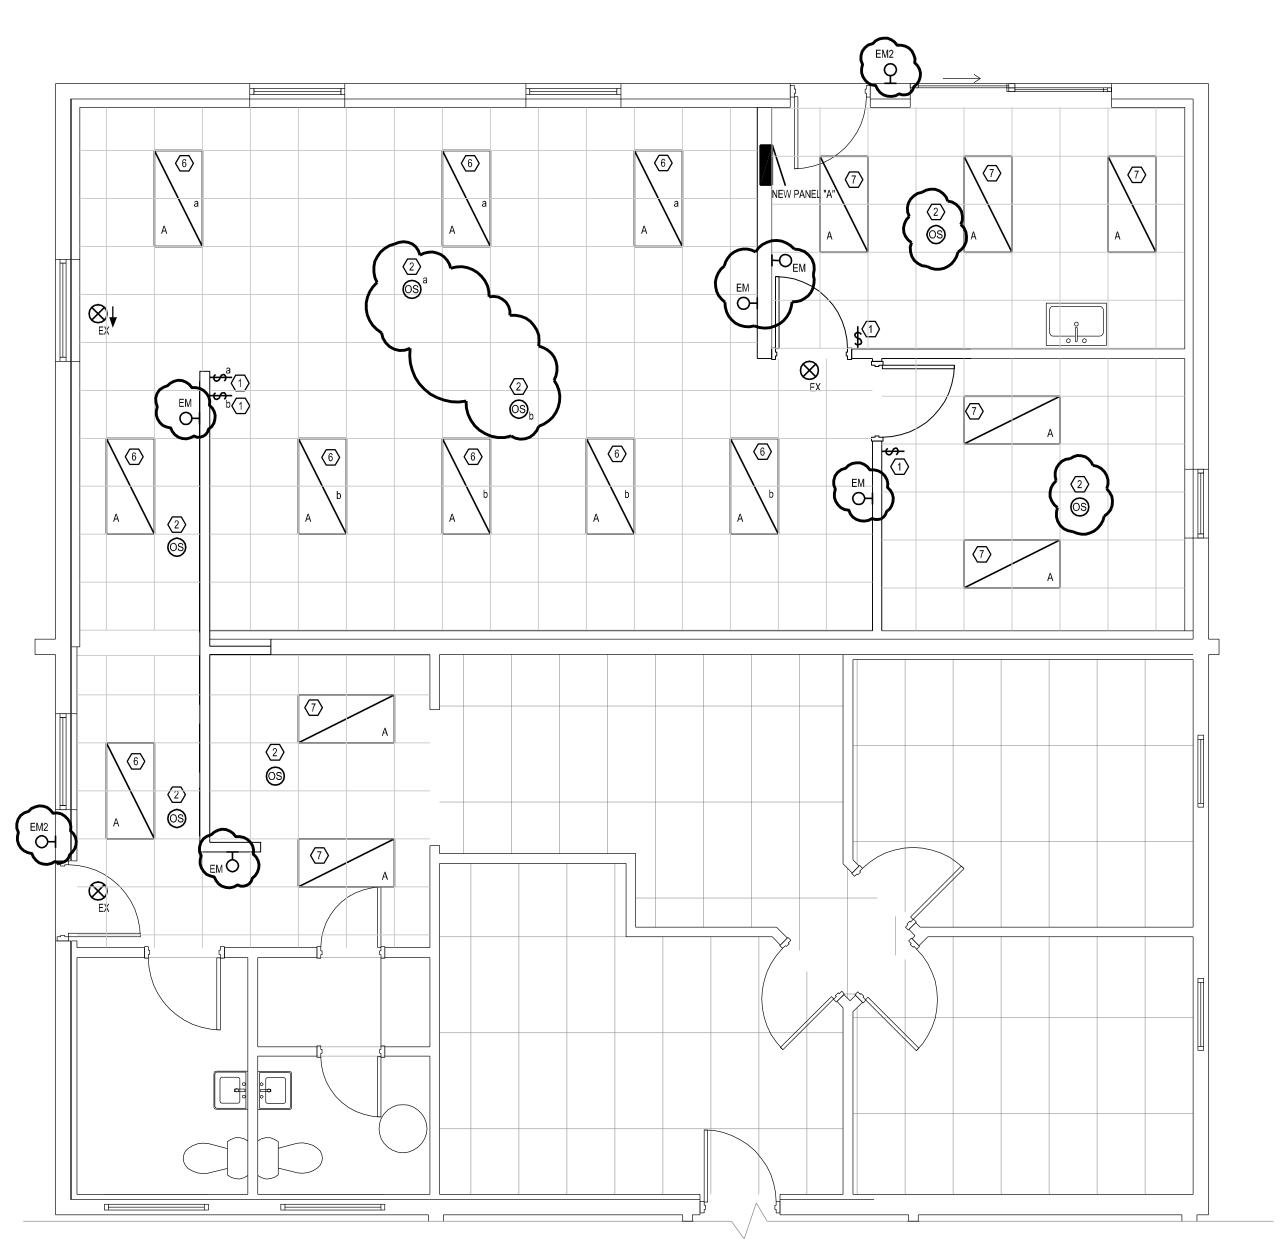
DEMO PLAN 23-153-01


REVISIONS

DATE

DRAWN BY MMA

APPROVED CWG



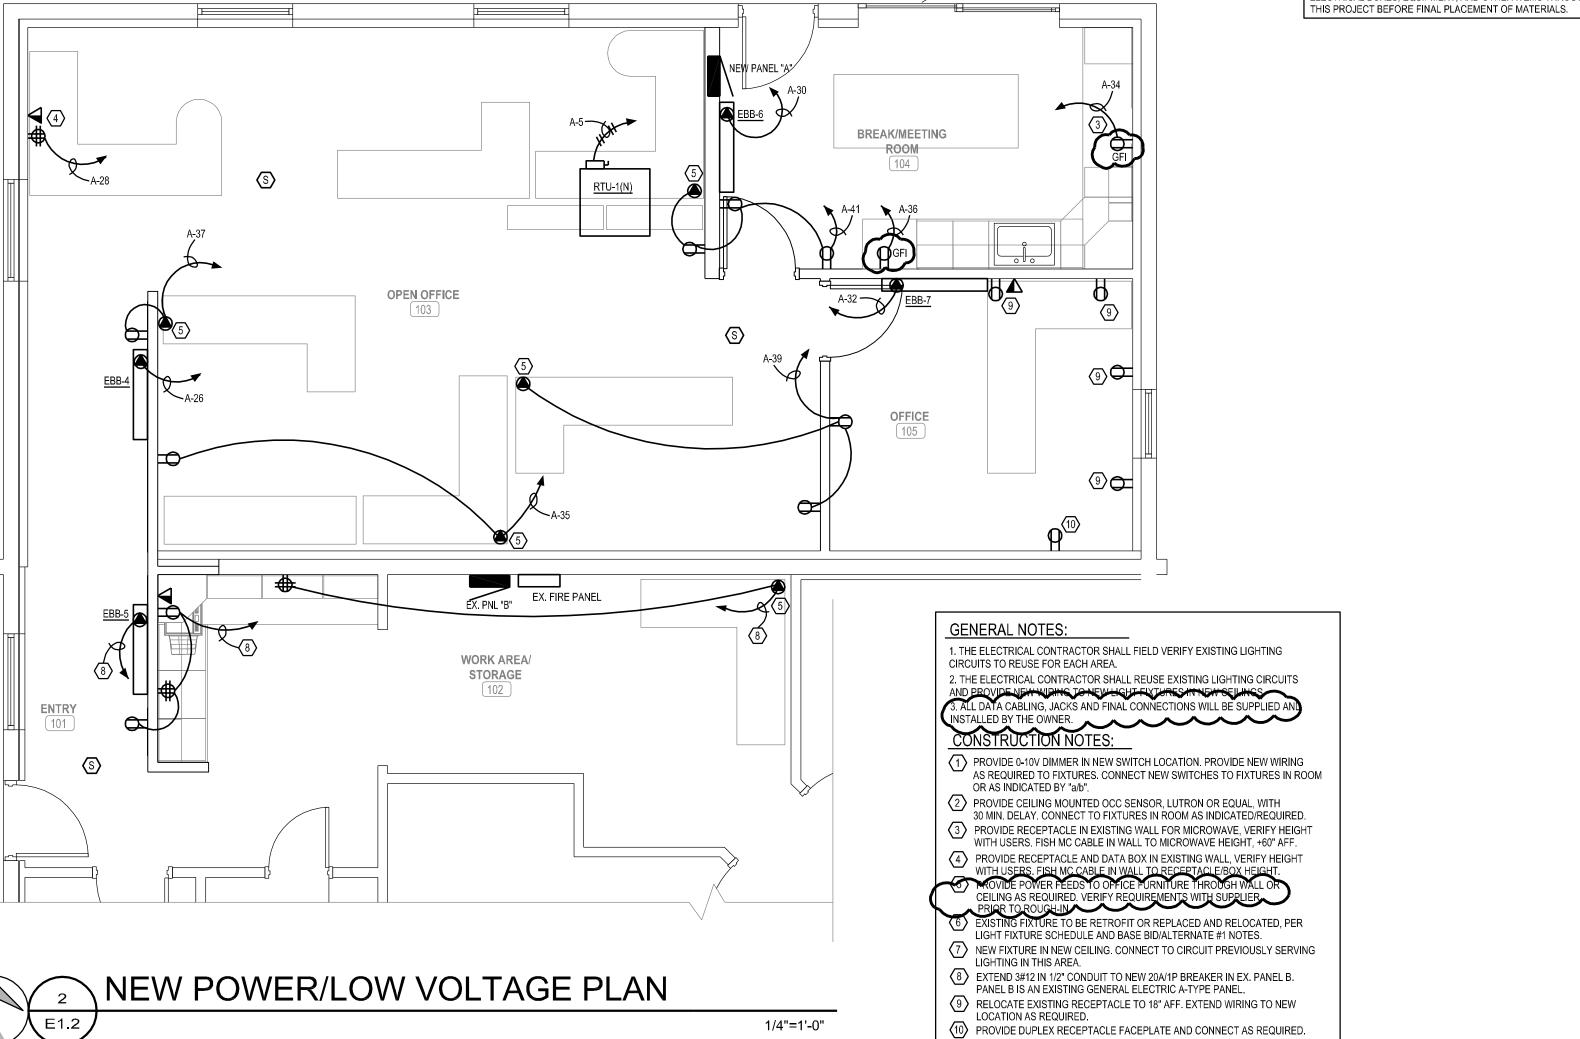

NEW LIGHTING PLAN
E1.2

LIGHT FIXTURE SCHEDULE LAMPS LTR. SYMBOL NOTES DESCRIPTION MANUFACTURER CATALOG NO. LOCATION MOUNTING WATTAGE 2'X4' RECESSED VOL24R-PS34-840-UD CEILING RECESSED ELKO 120V VOLUMETRIC RETROFIT KIT LED BASE DIMMABLE LED DIMMABLE LAMPING 2'X4' RECESSED CPANL-2X4-40LM-40K 32W CEILING RECESSED LITHONIA 120V FLAT PANEL DIMMABLE LED LED DIMMABLE LAMPING SINGLE FACE RED LED JSHED ALUM. STENCILED EXIT NICKEL CAD. BATTERY CLG. LQC-1R-120-ELN SURFACE LITHON THERMOPLASTIC EMERGENCY 5.4W ELM LITHONIA LIGHT W/ LEAD CALCIUM WALL 7' AFF H.I.T. BATTERY, 2 HEADS STAND ALONE SURFACE 7' AFF AFN-B-EXT EXTERIOR EMERGENCY FIXTURE LITHONIA LED

BASE BID: PROVIDE RETROFIT KIT IN NINE EXISTING 2X4 TROFFERS. FIELD VERIFY KITS WILL FIT INTO EXISTING FIXTURES PRIOR TO ORDERING.
ALTERNATE #1: PROVIDE NEW FIXTURES TO REPLACE NINE EXISTING LIGHTS.

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UNIT	HP	PH	VOLTS	MFR	CATALOG NO.	SIZE	POLES	HTRS	SWITCH	PILOT	EQUIP. & DEVICES	NOTES
EBB-4,5,7	1kW	1	120		N/A							1
EBB-6	750W	1	120		N/A							1
RTU-1(N)	18.8 MCA	1	240		N/A							12
1) SEE TEMP	ERATU	IRE C	ONTROL	SPECIFICATIONS	IN MECHANICAL S	SPECS F	OR SEQI	JENCE C	F OPERAT	ION, INTE	RLOCKS, AND SPECIAL	

SEE TEMPERATURE CONTROL SPECIFICATIONS IN MECHANICAL SPECS FOR SEQUENCE OF OPERATION, INTERLOCKS, AND SPECIAL CONTROLS REQUIRED; ALSO FOR DEFINITION OF WHICH CONTRACTOR PROVIDES WHAT.

1/4"=1'-0"

PROVIDE NEMA 3R, 30A/2P FUSED DISCONNECT SWITCH ADJACENT TO UNIT. PROVIDE FUSES PER MANUFACTURER'S RECOMMENDATIONS. ALL WORK RELATED TO THE REPLACEMENT OF THE RTU SHALL BE PART OF ALTERNATE #2.

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| MONTANA FWP - CWG PROJECT #23-153-01 FWP PROJECT #71991 | MONTANA OUTDOORS OFFICE REMODEL | 930 CUSTER AVENUE, HELENA, MT 59602

HEDULE!

AND

POWER/LOW VOLTAGE PLANS

AND

COORDINATION NOTE

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REVISIONS

23-153-01

DRAWN BY SHA

APPROVED SHA

DATE 11.04.2021

165.4 AMPS

Mechanica Addenda Items for MT Outdoors Addendum #1 11/04/2021

Clarification:

- 1) On the Electric Baseboard Schedule note #1 is to read "Complete with integral thermostat, disconnect means, high limit protection, factory white finish."
- 2) MECHANICAL SPECIFICATION NOTE: All work shall be in strict compliance with all applicable codes & standards, including but not limited to, 2018 IMC, 2018 UPC, 2018 IBC, 2018 IFGC & 2018 IECC. Contractor shall be responsible for obtaining permits, plan reviews, and all required ispections by the code authorities having jurisdiction.
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- 4) ROOFTOP UNIT: McQuay, Carrier, Trane, and Johnson Controls are approved to bid the Rooftop Unit. It is the responsibility of the G.C. to coordinate any deviations from the plans with all other trades at no additional cost to the owner if a unit other than the one scheduled on the plans is used.

Attachments: None

End of Mechanical Addendum #1



ENGINEERING, LLC

Electrical Design & Consulting 815 Jade St., Helena, MT 59602 Phone/Fax: (406) 458-0494 e-mail:susanhames@mt.net

ELECTRICAL ADDENDUM ITEMS

PROJECT: FWP MT Outdoors Office Remodel, Helena, MT

DATE: October 28, 2021

Light Fixture – Prior Approvals:

The following light fixtures have been reviewed as equals, subject to final approval, to specified light fixtures:

Fixture "A (base)" Litetronics
Fixture "A (alternate)" Litetronics
Fixture "EX" Mule Lighting

End of Electrical Addendum